TESSERE 1525 E. Douglas Wichita, KS 67211

PUBLIC PARKING GARAGE ELEVATOR SEDGWICK COUNTY 603 N. MAIN, WICHITA, KS 67203

ARCHITECT'S PROJECT 00930R25001

ADDENDUM 01

Tuesday, July 8, 2025

The original Project Manual and Drawings, dated June 12, 2025, for the Project noted above, are amended as indicated on this Addendum 01.

This Addendum consists of 6 pages and 2 Drawings.

Manufacturers approved by this Addendum shall not be relieved of the responsibility to comply with the specifications stated or, if not stated, the standard specifications and accessories supplied with the item specified.

Note: Receipt of this Addendum shall be acknowledged on your Bid Form. Failure to do so may subject the Bidder to disqualification.

ITEM NO.

CHANGES TO PRIOR ADDENDA (Does Not Apply)

CHANGES TO BIDDING REQUIREMENTS (Does Not Apply)

INVITATION TO BID (Does Not Apply)

INSTRUCTIONS TO BIDDERS

 ADD 1-1
 METROPOLITAN AREA BUILDING AND CONSTRUCTION DEPARTMENT (MABCD) – PLANS APPROVAL REQUIREMENTS: All bidders must abide by MABCD Standard Items 1 through 8. Item 9 pertains to existing conditions of existing fire extinguisher equipment. See attached Plans Approval Requirements document.

CHANGES TO CONDITIONS OF THE CONTRACT (Does Not Apply)

CHANGES TO SPECIFICATIONS (Does Not Apply)

CHANGES TO DRAWINGS

<u>ADD 1-2</u> <u>SHEET G-101 – CODE NARRATIVE AND PLANS:</u> Sheet Keynote 4 modified per MABCD Item 10.

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<u>ADD 1-3</u> <u>SHEET A-101 – ARCHITECTURAL PLANS AND DETAILS:</u> Sheet Keynote 11 added due to observed damaged concrete masonry unit (CMU) during the Pre-Bid Meeting on June 25, 2025.

GENERAL CLARIFICATIONS

ADD 1-4 SCOPE OF WORK:

- A. Otis Elevator has been awarded the elevator modernization. Finishes as shown in Exhibit A in the Project Manual.
- B. General Contractors Bidding on the Project Are Responsible for, but Not Limited to, the Following:
 - 1. All elements in the Project Manual and Construction Documents issued on June 12, 2025.
 - 2. Coordination with the County and their elevator contractor (Otis).
 - 3. Coordination with the County and their IT Department.

ADD 1-5 PRE-BID QUESTIONS AND ANSWERS:

- A. Can you provide Otis Elevator contact information?
 - 1. Kyle George, phone (913) 209-5958, e-mail kyle.george@otis.com.
- B. Do you plan to block off an area in front of the elevator(s) as a designated work zone?
 - 1. It is the responsibility of the General Contractor to coordinate with Sedgwick County and the Police Station to protect any area of work zone for all safety of the workers and the public.
- C. Can photos be provided of the areas that were not accessed during the pre-bid meeting?
 - 1. All photos of the jobsite have been provided via e-mail on June 25, 2025.
- D. Does the work scope involve any painting?
 - 1. Touchup paint will be required of areas of construction. Paint shall match existing.
- E. Is there an electrical bay/room?
 - 1. There is a small electrical room on the west side of the building next to the west elevator mechanical room.

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- F. Are the air conditioner units being replaced?
 - 1. Yes, see Electrical Drawings.
- G. What hours/days are we allowed to work? Anytime? Weekends?
 - 1. Monday through Friday during normal business hours is anticipated. However, arrangements can be made if weekend work or off-hour work is needed.

END OF ADDENDUM 01

METROPOLITAN AREA BUILDING & CONSTRUCTION DEPARTMENT 660-1756 PLANS APPROVAL REQUIREMENTS

Project: SG Parking Garage Elevator Replacement **Project Number:** PLR2025-00331 **Project Location:** 603 N. Main **Date Plans Submitted:** 6-13-25

The building plans have been reviewed. Requirements for this project are listed below.

The "Standard Requirements" listed below are routine and sometimes overlooked during construction, and are requirements for this project regardless of what may or may not be shown on the approved plans. You may authorize this list of requirements to become part of the specifications for the project, to be attached to and considered part of the plans.

Standard item numbers 1 through 9 listed below shall be specifications for the construction of this project without additional changes to the plans.

The "Specific Requirements" listed below will require revised plans correcting the problem to be resubmitted for review and approval before a permit can be issued.

The plans shall be revised to include specific item number 10 listed below.

NOTE: If there is an omission of any requirement on the submitted plans or any omission or error occurs during the review of the plans, such omission or error shall in no way authorize any violation of the codes, ordinances or regulations of The City of Wichita.

Please contact me at (316) 660-1756 or via email at <u>Michele.gideon@sedgwick.gov</u> if you wish to discuss this matter or if I can be of assistance to you. Final approval of the plans will be withheld until we receive, review and approve the revised plans.

ZONE: GC OCC.: S2 CONST. TYPE: 2B FIRE SPRINKLER SYSTEM: No FIRE ALARM: existing-no change

THIS MABCD PLAN REVIEW IS ONLY FOR GENERAL CONFORMANCE WITH THE APPLICABLE CODES AND ORDINANCES. CORRECTIONS, COMMENTS, ERRORS OR OMISSIONS ON THESE DRAWINGS DO NOT RELIEVE THE CONTRACTORS, PROJECT DESIGNERS AND PROPERTY OWNERS FROM COMPLIANCE WITH ALL REQUIREMENTS OF THE APPLICABLE CODES AND ORDINANCES. COMPLIANCE WITH ALL REQUIREMENTS OF THE APPLICABLE CODES, ORDINANCES AND STANDARDS IS REQUIRED REGARDLESS OF WHAT IS OR IS NOT SHOWN ON THE APPROVED PLANS. THE CONTRACTORS ARE ALSO RESPONSIBLE FOR CONFORMING TO ALL APPROVED METHODS OF CONSTRUCTION.

BY: Michele Gideon

Plans Approval Requirements

Project: SG Parking Garage Elevator Replacement **Page:** 2

STANDARD REQUIREMENTS:

General Requirements:

- 1. Reinforcing steel or structural framework of any part of any building or structure shall not be covered or concealed without receiving inspection approval by the Metropolitan Area Building and Construction Department. In addition to required electrical, mechanical and plumbing inspections, the building permit holder or his agent shall request the Metropolitan Area Building and Construction Department to make the following called building construction inspections and approvals:
 - a. Footing, foundation and reinforcement inspection prior to the pouring of concrete.
 - b. Framing inspection after all electrical, mechanical, plumbing and gas piping is installed, and prior to concealing any framework.
 - c. Insulation inspection prior to concealing, and wallboard inspection.
 - d. Final Inspection prior to any use or occupancy of the building or area.
- 2. A set of paper building plans and specifications that are stamped by the Metropolitan Area Building and Construction Department shall be kept on the project site during construction until final inspection approval has been made. Approved electronic drawings will be located in the "approved" folder in Project Dox under the project PLR number and must be downloaded and printed for use on the project site.
- 3. Changes made during construction of a project that affects exiting, wall configuration and structural elements that are not just "cosmetic", require revised plans to be submitted to the Metropolitan Area Building and Construction Department for review and approval. If a licensed Architect or Engineer sealed the original plans, the revised plans must also be sealed, signed and dated with the current revision date.
- 4. Engineering firms are responsible for meeting all applicable codes. The contractor for each trade is responsible for making sure the work meets the codes. MABCD inspectors inspect the work for compliance with the codes for the City of Wichita and other towns that have contracts with MABCD.
- 5. Stamped plans for other agencies/departments that MABCD does not review are done in good faith. It is the responsibility of the those in charge of the project to get all required reviews, approvals, permits, and inspections from those agencies/departments.
- 6. For copies of permits and payment assistance, email <u>MABCD@sedgwick.gov</u> For assistance with the portal, project dox, and hansen contact <u>Debra.holder@sedgwick.gov</u>
- 7. Elevator inspections are done by MABCD.(1) Elevator plans approved by Electrical Chief Nordick on 6-23-25

Fire Department Requirements:

8. Before a Certificate of Occupancy is issued, compliance with the 1018 Edition of the International Fire Code Section 510 is required by means of an Emergency Responder Radio Coverage System (ERRCS) installed, tested, and accepted or through field-testing by a FCC licensed radio contractor to verify that an ERRCS is not required (survey). A field test (radio survey) is required for all construction projects (remodel/renovations or new). A failed field test (radio survey) for new construction will require the installation of ERRCS. For information on the above, contact the Community Risk Reduction Division of the Wichita Fire Department at (316) 268-4441.

Plans Approval Requirements

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9. The building shall be equipped with 2A-10BC minimum rated fire extinguishers. The extinguishers shall be located so that the maximum travel distance to them does not exceed 75 ft. from any point in the area to meet IF.C. Sec. 906.1.

<u>SPECIFIC REQUIREMENTS</u>: For the plan revisions requested below, electronically submit revised drawings with the applicable Kansas licensed Architects or Engineers seal (whichever is required by the contents of the drawings) through Project Dox. Each design professional's seal shall be signed and dated with the most current revision date.

When re-submitting drawings electronically to Project Dox, upload revised plans to the "Drawings" folder as individual files. Revised re-submitted files must be named exactly the same as the original files submitted (characters, case, spaces, dots, dashes, etc.) to allow the system to work as intended. A "V2" (version number) will appear by the file name when the revised file is named correctly. Do not change plan sheet names or sheet+ numbers from those originally submitted. It is the responsibility of the applicant to upload required documents and/or revisions to Project Dox prior to the next review.

General Requirements:

*10. Indicate on Sheet G-101 Sheet Keynote Number 4 that the new Elevator Emergency Communication Systems in each car will comply with IBC Section 3001.2 to meet IEBC Section 306.7.7.

Michele Gideon Building Plans Examiner Date: 6-16-25

AUTHORITY HAVING JURI		OCAL: METROPOLITAN AREA AND E CONSTRUCTION DEPARTME 271 W. 3RD STREET N. WICHITA, KS 67202 TEL: (316) 660-1840 TATE: KANSAS STATE FIRE MARSH	NT (MABCD)
CODE BUILDING CODE	TITLE INTERNATIONAL BUI		EDITION 2024
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FIRE PREVENTION ELEVATORS	INTERNATIONAL FIRE ASME A17.1-2022 SAF		2018 2022
USE AND OCCUPANCY:	ESCALATORS		
USE GROUP GROUP S-2	OCCUPANCY CLASS	IFICATION AGE (PUBLIC PARKING GARAGE)	IBC Sect 311
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Building Height Type IIB	ALLOWABLE(FT) 55 FT	ACTUAL(FT) UNCHANGED	Table 504
	3 STORIES		IBC Sect 506 C
BUILDING AREA TYPE IIB	ALLOWABLE(SF) 39,000 SF	ACTUAL(SF) UNCHANGED	Sect 506.2
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OCCUPANCY GROUP S-2	FIRE-RES	SISTANCE RATING (HR) 2	Table 707.3.10
PENETRATIONS THROUGH FIRE-RESISTA		NS	IBC Sect 714.3
OPENING PROTECTIVES	FIRE-RESIST.	ANCE RATING (HR)	IBC
FIRE DOOR RATINGS	FIRE BARRIE		Table 716.1(2)
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CODE NARRATIVE - K.A.R. 22-1-7

BUILDING PROJECT TYPE: (2) ELEVATOR REPLACEMENTS

PROJECT DESCRIPTION THIS PROJECT IS TO MODERNIZE AND REPLACE EQUIPMENT FOR TWO ELEVATORS IN ONE OF THE PARKING GARAGES OWNED BY SEDGWICK COUNTY.

OWNER: SEDGWICK COUNTY

FACILITY NAME: SEDGWICK COUNTY PARKING GARAGE

DESIGNERS:

RCHITECT:	MECHANICAL AND ELECTRICAL ENGINEERS:
ESSERE	INTEGRATED CONSULTING ENGINEERS, INC.
525 E. DOUGLAS	349 SOUTH HYDRAULIC
ICHITA, KS 67211	WICHITA, KS 67211
(316) 265-9367	P: (316) 264-3588
(316) 265-5646	

THE INFORMATION REPRESENTED ON THE FOLLOWING DRAWINGS RESPOND TO REQUIREMENTS OF K.A.R. 22-1-7 CODE FOOTPRINT.

THE DRAWINGS LISTED BELOW RESPOND TO K.A.R. 22-1-7 (a) and (b):

- G-101 CODE NARRATIVE AND PLANS
- **NO ANTICIPATED FUTURE ADDITIONS**

THE FOLLOWING NARRATIVE RESPOND TO K.A.R. 22-1-7 (c):


- (1) PROJECT CONSTRUCTION PURPOSE: REPLACEMENT OF EXISTING ELEVATORS (2) REASON FOR SUBMITTAL: RENOVATION
- (3) APPLICABLE CODES: 2024 INTERNATIONAL BUILDING CODE (IBC)
 - 2024 INTERNATIONAL EXISTING BUILIDING CODE (IEBC)
 - 2018 INTERNATIONAL FIRE CODE (IFC) 2021 UNIFORM PLUMBING CODE (UPC)
 - 2024 INTERNATIONAL MECHANICÀL CÓDE (IMC)
- 2023 NFPA 70 NATIONAL ELECTRIC CODE ASME 117.1-2022 - SAFETY CODE FOR ELEVATORS AND ESCALATORS
- KANSAS FIRE PREVENTION CODE (4) BUILDING LOCATION:
- 603 N. MAIN STREET, WICHITA, KS 67203
- (5) OWNER:

THE PROJECT IS BEING ADMINISTERED BY SEDGWICK COUNTY SANDY ANGUELOV 271 W. 3RD STREET SUITE 325

- WICHITA, KS 67202
- OFFICE: (316) 660-9853 CELL: (206) 234-5434
- (6) DATES: DATES AND REVISIONS ARE SHOWN ON THE SHEET TITLE BLOCK
- (7) DESIGNER'S INFORMATION: SHOWN ABOVE AND ON THE SHEET TITLE BLOCK
- (8) DESIGNERS SEAL: AFFIXED TO THE SHEET TITLE BLOCK
- (9) RESPONDING FIRE SERVICE: CITY OF WICHITA DEPARTMENT
 - 731 N MAIN
- WICHITA, KS 67203
- (10) LOCAL BUILDING INSPECTION DEPARTMENT: METROPOLITAN AREA BUILDING AND CONSTRUCTION DEPARTMENT
- (MABCD) 271 WE. 3RD STREET N.
- WICHITA, KS 67202
- OFFICE: (316) 660-1840 (11) OCCUPANCY GROUP AND TYPE:
- OCCUPANCY GROUP: S-2
- (12) TYPE OF CONSTRUCTION: II-B ASSUMED

CODE PLAN LEGEND							
	2-HOUR FIRE BARRIER; IBC SECTION 707 (OCCUPANCY SEPARATION) 90-MIN. RATED DOOR ASSEMBLY. FIRE DAMPERS.						
®	FIRE DOOR ASSEMBLY RATING						
FH	FIRE HYDRANT DISTANCE FROM BUILDING SHOWN ON SITE PLAN						
NAME 101 100SF 100/OCC 1 OCC	ROOM NAME ROOM NUMBER (OMITTED AT AREAS) AREA OF ROOM OR AREA OCCUPANT LOAD FACTOR NUMBER OF OCCUPANTS						

SHEE I FLOT

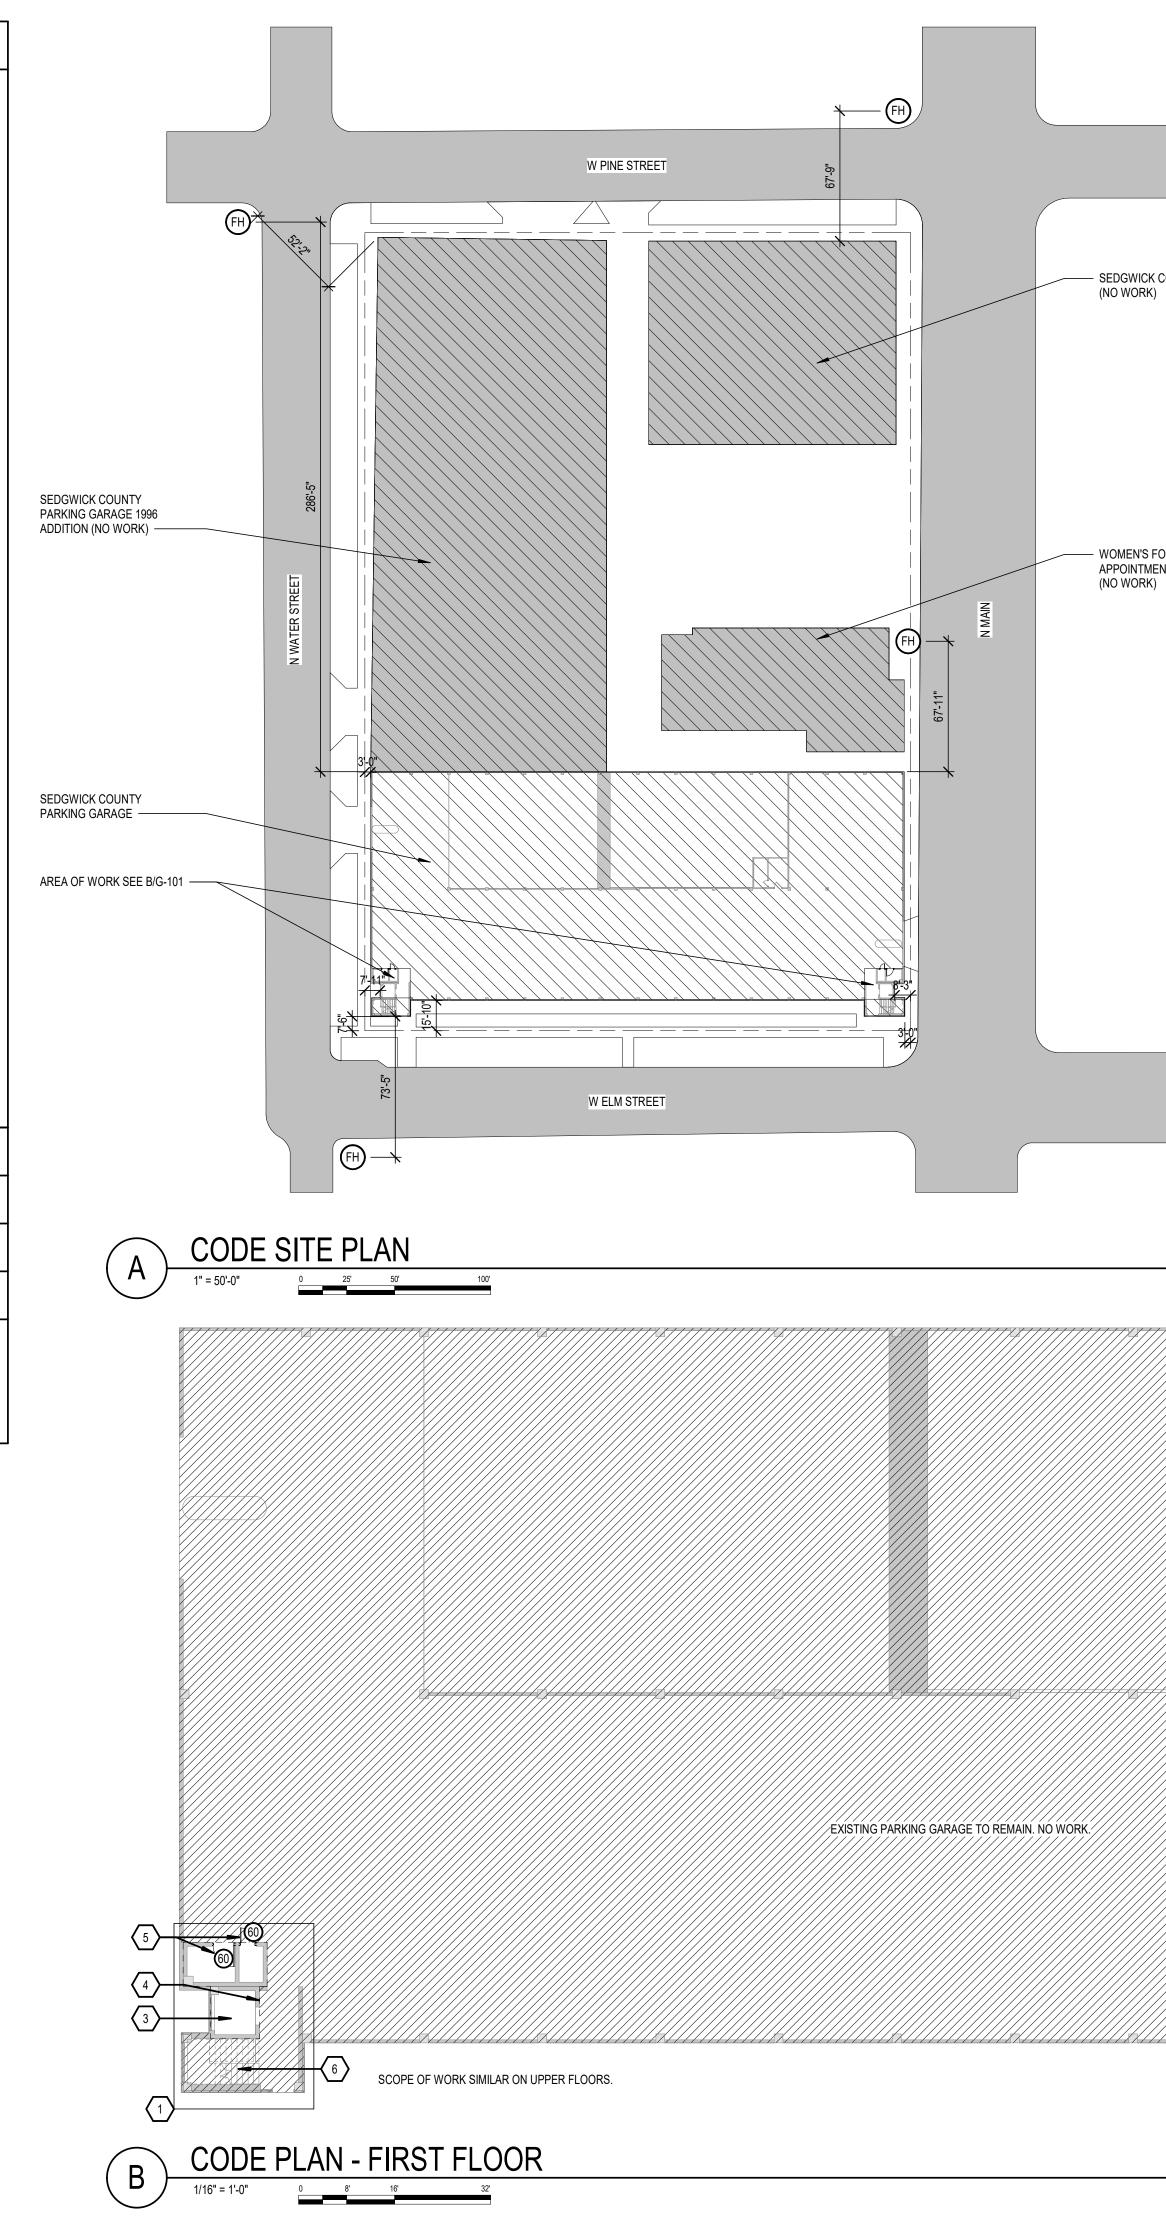

SEDGWICK COUNTY BILLING (NO WORK)

SHEET KEYNOTES

DESCRIPTION # | 1 PHASE 1: WEST ELEVATOR AND SUPPORTING ROOMS

ADD01

 2
 PHASE 2: EAST ELEVATOR AND SUPPORTING ROOMS

 3
 ELEVATOR CAB TO REMAIN. DEMO AND REPLACE FLOOR FINISH, WALL PANELS, TRIM,

 RAILING AND GLASS
 NEW ELEVATOR COMMUNICATION TO BE INSTALLED AT ALL LEVELS AT EACH CAR IN COMPLIANCE WITH IBC SECTION 3001.2 TO MEET IEBC SECTION 306.7.7.
 DEMO EXISTING DOORS AND REPLACE WITH NEW 1HR FIRE RATED DOORS. 6 EXISTING STAIRS TO REMAIN. NOT PART OF PROJECT SCOPE.

WOMEN'S FOUNDATION APPOINTMENTS PROJECT



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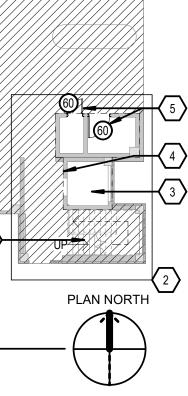
SED 603 N MA


ADD01	ADD 01 DESCRIPTIO	07/08/2025 N DATE		
PROJEC	T NO:	00939R25001		
STATUS	: CE	CERTIFIED FINAL		
DATE:		6/12/2025		
DRAWN	BY:	CGK		
CHECKE	ED BY:	NLK		

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CODE NARRATIVE AND PLANS





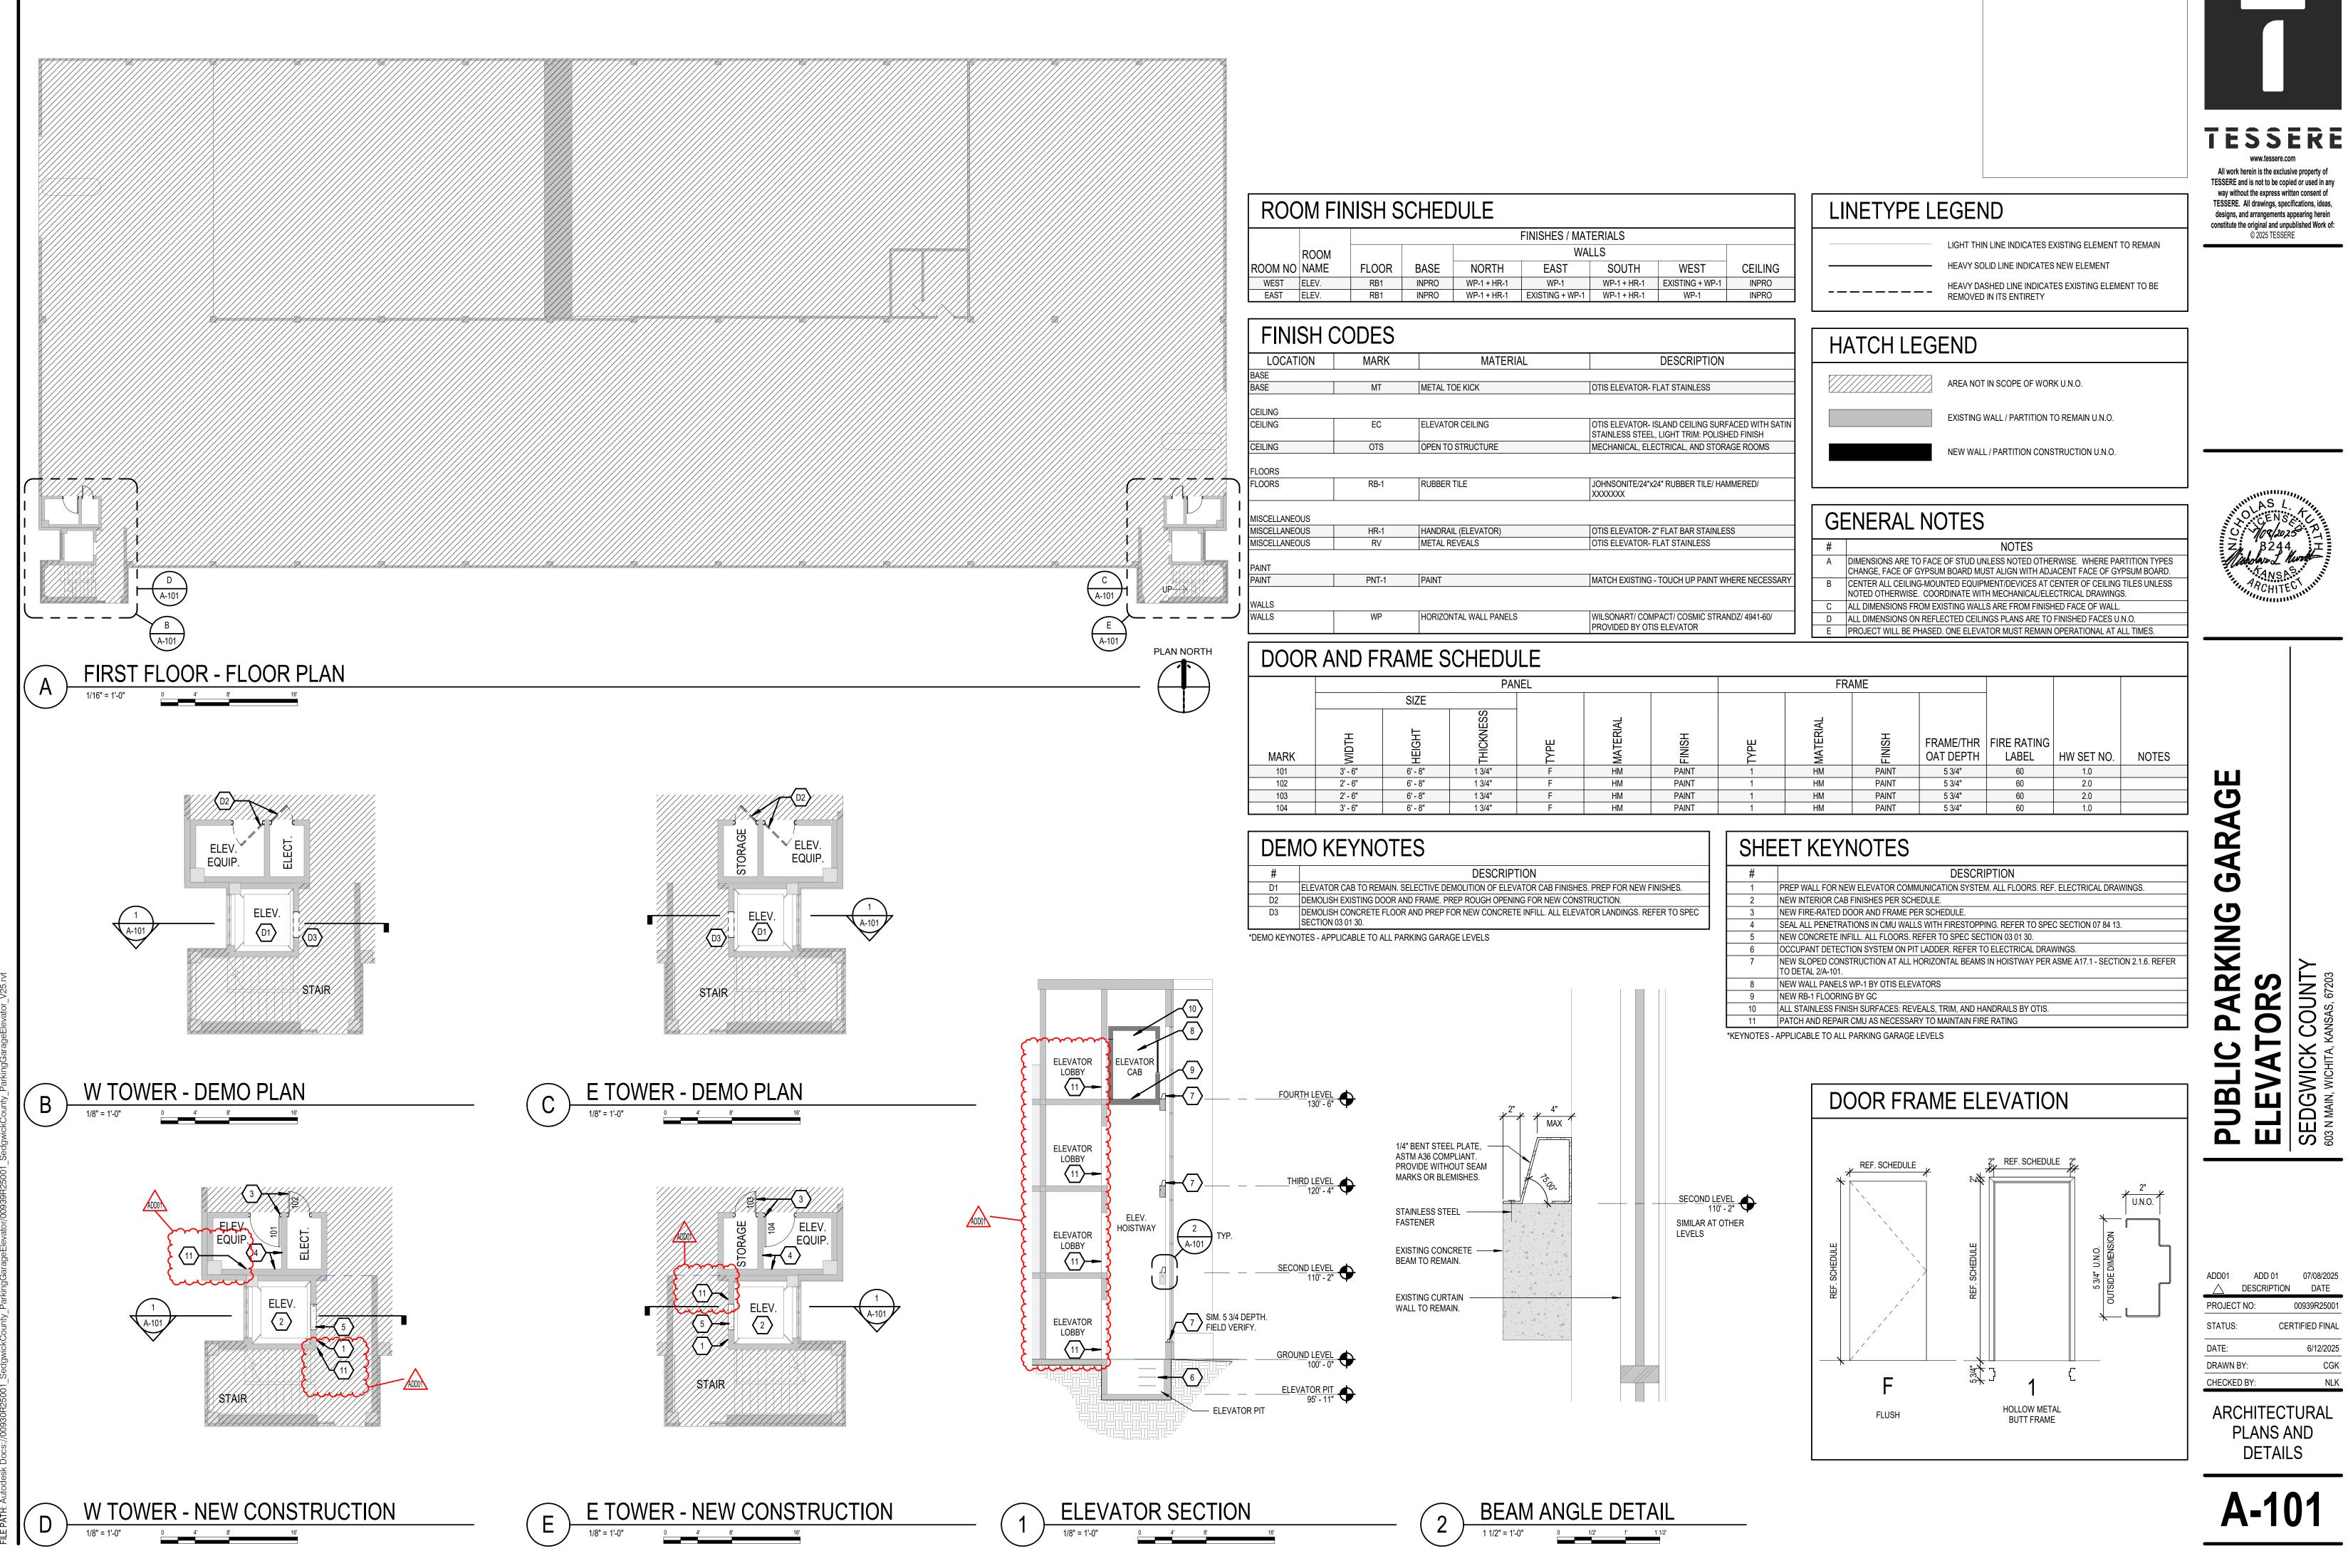

					FINISHES / MAT	ERIALS
	ROOM				WA	LLS
ROOM NO	NAME	FLOOR	BASE	NORTH	EAST	SOL
WEST	ELEV.	RB1	INPRO	WP-1 + HR-1	WP-1	WP-1
EAST	ELEV.	RB1	INPRO	WP-1 + HR-1	EXISTING + WP-1	WP-1

LOCATION	MARK	MATERIAL	
BASE			
BASE	MT	METAL TOE KICK	OTIS ELE
CEILING			
CEILING	EC	ELEVATOR CEILING	OTIS ELE STAINLES
CEILING	OTS	OPEN TO STRUCTURE	MECHAN
FLOORS			
FLOORS	RB-1	RUBBER TILE	JOHNSON XXXXXXX
MISCELLANEOUS			
MISCELLANEOUS	HR-1	HANDRAIL (ELEVATOR)	OTIS ELE
MISCELLANEOUS	RV	METAL REVEALS	OTIS ELE
PAINT			
PAINT	PNT-1	PAINT	MATCH E
WALLS			
WALLS	WP	HORIZONTAL WALL PANELS	WILSONA

	PANEL						FRAME						
	SIZE												
MARK	WIDTH	НЕІСНТ	THICKNESS	ТҮРЕ	MATERIAL	FINISH	ТҮРЕ	MATERIAL	FINISH	FRAME/THR OAT DEPTH	FIRE RATING LABEL	HW SET NO.	NOTES
101	3' - 6"	6' - 8"	1 3/4"	F	HM	PAINT	1	HM	PAINT	5 3/4"	60	1.0	
102	2' - 6"	6' - 8"	1 3/4"	F	HM	PAINT	1	HM	PAINT	5 3/4"	60	2.0	
103	2' - 6"	6' - 8"	1 3/4"	F	HM	PAINT	1	HM	PAINT	5 3/4"	60	2.0	
104	3' - 6"	6' - 8"	1 3/4"	F	HM	PAINT	1	HM	PAINT	5 3/4"	60	1.0	

	#	DESCRIPTION
IES.	1 PREP W	ALL FOR NEW ELEVATOR COMMUNICATION SYSTEM. ALL FLOORS. REF. ELECTRICAL DRAWINGS.
	2 NEW INT	ERIOR CAB FINISHES PER SCHEDULE.
O SPEC	3 NEW FIR	E-RATED DOOR AND FRAME PER SCHEDULE.
	4 SEAL AL	L PENETRATIONS IN CMU WALLS WITH FIRESTOPPING. REFER TO SPEC SECTION 07 84 13.
	5 NEW CO	NCRETE INFILL. ALL FLOORS. REFER TO SPEC SECTION 03 01 30.
	6 OCCUPA	NT DETECTION SYSTEM ON PIT LADDER. REFER TO ELECTRICAL DRAWINGS.
		DPED CONSTRUCTION AT ALL HORIZONTAL BEAMS IN HOISTWAY PER ASME A17.1 - SECTION 2.1.6. REFER AL 2/A-101.
	8 NEW WA	LL PANELS WP-1 BY OTIS ELEVATORS
		-1 FLOORING BY GC
		INLESS FINISH SURFACES: REVEALS, TRIM, AND HANDRAILS BY OTIS.
	11 PATCH A	ND REPAIR CMU AS NECESSARY TO MAINTAIN FIRE RATING
		3LE TO ALL PARKING GARAGE LEVELS
		DOOR FRAME ELEVATION
		REF. SCHEDULE 2"

SEDGWICK COUNTY PUBLIC PARKING GARAGE ELEVATORS CERTIFIED FINAL

OWNER: SEDGWICK COUNTY 538 N MAIN ST WICHITA, KS 67203 P: (319) 660-9853 CONTACT: SANDY ANGUELOV E: sandy.anguelov@sedgwick.gov

ARCHITECT:

TESSERE 1525 E. DOUGLAS WICHITA, KS 67211 P: (316) 265-9367 CONTACT: PROJECT MANAGER E: nick.kurth@tessere.com CONTACT: PROJECT ARCHITECT/DESIGNER E: christian.kaufman.com

MECHANICAL / ELECTRICAL: INTEGRATED CONSULTING ENGINEERS, INC. 349 SOUTH HYDRAULIC WICHITA, KS 67211 P: (316) 264-3588 CONTACT: DREW ROSE E: drose@iconengineers.net






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LIC PARKING (ATORS ICK COUNTY

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DESCRIPTION DATE PROJECT NO: 00939R25001 STATUS: CERTIFIED FINAL DATE: 6/12/2025 DRAWN BY: CGK CHECKED BY: NLK

COVER SHEET

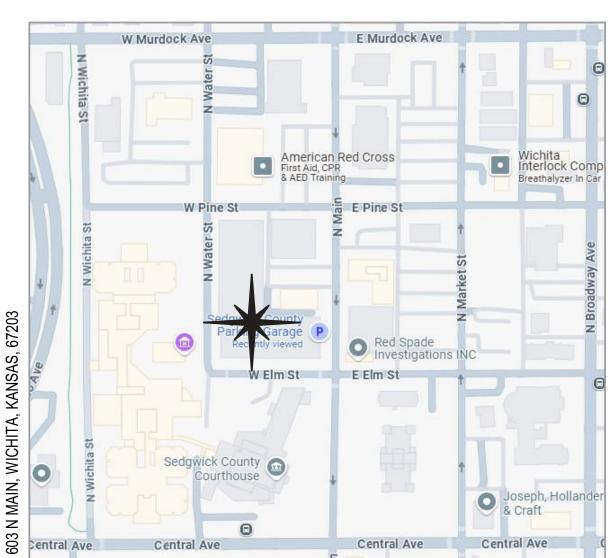

ABBREVIATION	TERMINOLOGY
A	
ABV / ABV. AFF / A.F.F.	ABOVE ABOVE FINISH FLOOR
ACS PNL	ACCESS PANEL
ACT / A.C.T.	ACOUSTICAL CEILING PANEL ADJACENT
ADJ / ADJ. A/C / A.C.	AIR CONDITIONING
ALT / ALT.	ALTERNATE
ALUM / ALUM.	ALUMINUM
AIA ADA	AMERICAN INSTITUTE OF ARCHITECTS AMERICANS WITH DISABILITIES ACT
ada ANOD / ANOD.	ANODIZED
APPROX / APPROX.	APPROXIMATE
ARCH / ARCH.	ARCHITECT (URAL)
AVG / AVG.	AVERAGE
В	
BSMT / BSMT.	BASEMENT
BATH BRG / BRNG.	BATHROOM BEARING
BLW / BLW.	BELOW
BTWN / BTWN.	BETWEEN
BLK / BLK.	BLOCK
BLKG / BLKG.	BLOCKING BOARD
BD / BD. B.O.	BOTTOM OF
BLDG / BLDG.	BUILDING
BIM / B.I.M.	BUILDING INFORMATION MODEL
C	
C CIP / C.I.P.	CAST IN PLACE
CLK	CAULK (ING)
CLG	CEILING
CL / C.L.	
C/C CO / C.O.	CENTER TO CENTER CLEAN OUT
CLR	CLEAR (ANCE)
CLO / CLOS.	CLOSET
COL/COL.	COLUMN
CONC / CONC. CMU / C.M.U.	CONCRETE CONCRETE MASONRY UNIT
CONST / CONST.	CONSTRUCTION
CJ / C.J.	CONSTRUCTION JOINT / CONTROL JOINT
CONT / CONT.	
CI / C.I. CG / C.G.	CONTINUOUS INSULATION CORNER GUARD
CORR / CORR.	CORRIDOR
CU FT	CUBIC FEET
CU YD	CUBIC YARD
D	
DEMO / DEMO.	DEMOLTION
DTL / DTL.	DETAIL
DIA / DIA.	DIAMETER
DIM / DIM. DW / D.W.	DIMENSION DISH WASHER
DBL / DBL.	DOUBLE
DN	DOWN
DS/D.S.	
DWG / DWG. DF/ D.F.	DRAWING (S) DRINKING FOUNTAIN
E	
EA / EA. ELEC / ELEC.	
ELEC / ELEC. ELEV / ELEV.	ELECTRIC (AL) ELEVATION / ELEVATOR
EQ / EQ.	EQUAL
EQUIP / EQUIP.	EQUIPMENT
EPDM	ETHYLENE PROPYLENE DIENE MONOMER
EXIST / EXIST. EXP / EXP.	EXISTING EXPANSION / EXPOSED
EJ/E.J.	EXPANSION / EXPOSED
EXT / EXT.	EXTERIOR
EIFS / E.I.F.S.	EXTERIOR INSULATION AND FINISH SYSTEM
F	
FAB / FAB.	FABRICATE / FABRICATION
FOW / F.O.W.	FACE OF WALL
F/F	
FRP / F.R.P. FV / F.V.	FIBERGLASS REINFORCED PANEL FIELD VERIFY
FIN / FIN.	FINISH
FF / F.F.	FINISH FLOOR
FDC / F.D.C.	
FE / F.E. FEC / F.E.C.	FIRE EXTINGUISHER FIRE EXTINGUISHER CABINET
FH / F.H.	FIRE HYDRANT
FRT / F.R.T.	FIRE RETARDANT TREATED
FCO / F.C.O.	FLOOR CLEAN OUT
FD / F.D. FT / FT. / (')	FLOOR DRAIN FOOT
FT/FT./() FTG	FOOTING
FDTN	FOUNDATION
FR / F.R.	FRAME (D) (ING) / FIRE RATED
F.O. FURN / FURN.	FRONT OF / FACE OF
I UNN / FUKN.	FURNITURE
G	
ga / ga.	GAGE / GAUGE
GALV / GALV.	GALVANIZED
GC / G.C. GEN / GEN.	GENERAL CONTRACTOR
GEN / GEN. GLZ	GENERATOR
GLULAM	GLUE LAMINATED LUMBER
GB / G.B.	GRAB BAR
	GROSS SQUARE FEET
GSF / G.S.F GYP / GYP.	GYPSUM

TERMS AND ABBREVIATIONS TERMINOLOGY ABBREVIATION HW / H.W. HARDWARE HDWD HARDWOOD HDR HEADER HVAC / H.V.A.C. HEATING, VENTILATIN AND AIR CONDITIONING HEIGHT HC/H.C. HOLLOW CORE / HANDICAP HM / H.M. HOLLOW METAL HORIZ / HORIZ. HORIZONTAL HOUR HYD/HYD. HYDRANT ID / I.D. IDENTIFICATION / INSIDE DIAMTER (DIMENSION) IN / IN. / (") INCH INSUL / INSUL. INSULATION INT / INT. INTERIOR IBC / I.B.C. INTERNATIONAL BUILDING CODE JAN / JAN. JANITORS CLOSET JOINT JST / JST JOIST LAM / LAM. LAMINATE (D) LVL / L.V.L. LAMINATED VENEER LUMBER LAV / LAV. LAVATORY LEFT-HAND LH/L.H. LEFT-HAND REVERSE LHR / L.H.R. LF/L.F. LINEAR FEET (FOOT) LKR / LKR. LOCKER MFD / MFD. MANUFACTURED MFR / MFR. MANUFACTURER MAS / MAS. MASONRY MATL / MATL. MATERIAL MAX / MAX. MAXIMUM MECH / MECH. MECHANICAL MDF / M.D.F. MEDIUM-DENSITY FIBERBOARD MEMB / MEMB. MEMBRANE MTL / MTL. METAL MIN / MIN. MINIMUM MIR / MIR MIRROR MISC / MISC. MISCELLANEOUS MODULAR / MODIFY MOD / MOD MR / M.R. MOISTURE RESISTANT MTD / MTD. MOUNTED NFPA / N.F.P.A. NATIONAL FIRE PREVENTION ASSOCIATION NRC / N.R.C. NOISE REDUCTION COEFFICIENT NOM / NOM. NOMINAL NA / N/A / N.A NOT APPLICABLE NOT IN CONTRACT NIC / N.I.C. NOT TO SCALE NTS / N.T.S. NO/NO. NUMBER OCC/OCC. OCCUPANT (S OSFM / O.S.F.M. OFFICE OF STATE MARSHALI ON CENTER (S) OTS/O.T.S. OPEN TO STRUCTURE OPNG / OPNG. OPENING OPP / OPP. OPPOSITE OD / O.D. OUTSIDE DIAMETER (DIMENSION) OVERFLOW ROOF DRAIN ORD / 0.R.D. OH / OVHD OVERHEAD PNT / PNT. PAINT PAIR / PIPE RAIL PR/PR. PTN / PTN. PARTITION PVMT / PVMT. PAVEMENT PERF / PERF. PERFORATED / PERFORM PERIM / PERIM. PERIMETER PH/P.H. PHASE PLBG. / PLUMB. PLUMBING PLYWD / PLYWD. PLYWOOD POLYISO / POLYISO. POLYISOCYANURATE PVC / P.V.C. POLYVINYL CHLORIDE LBS/lb/# POUNDS PCF / P.C.F. POUNDS PER CUBIC FOOT PLF / P.L.F. POUNDS PER LINEAR FOOT PSF / P.S.F. POUNDS PER SQUARE FOOT PSI / P.S.I. POUNDS PER SQUARE INCH PREFIN / PREFIN. PREFINISHED PT/P.T. PRESSURE-TREATED PROJ / PROJ. PROJECT / PROJECTOR PROPERTY LINE PL/P.LQTY/QTY. QUANTITY REF / REF. REFERENCE / REFRIGERATOR RCP/R.C.P. REFLECTED CEILING PLAN REINF / REINF. REINFORCE (MENT) REQ / REQ. / REQ'D REQUIRE (D) REQMT (S) REQUIREMENT (S) RESIST / RESIST. RESISTANT REV / REV. REVISE (D) / REVISION / REVERSE RH/R.H. RIGHT HAND / ROOF HATCH RHR / R.H.R. RIGHT-HAND REVERSE ROW / R.O.W. RIGHT-OF-WAY ROOF DRAIN / ROAD RD / R.D. RTU/R.T.U. ROOF TOP UNIT RM / RM. ROOM R0 / R.O. ROUGH OPENING

TERMS AND ABBREVIATIONS

	-		-	
				TF

ABBREVIATION	TERMINOLOGY
S SAN / SAN.	SANITARY
SCHED / SCHED.	SCHEDULE
SECT / SECT.	SECTION
SHT / SHT.	SHEET
SIM / SIM.	SIMILAR
SC / S.C.	SOLID CORE
STC / S.T.C.	SOUND TRANSMISSION CLASS
SPEC / SPEC.	SPECIFICATION
SPEC/SPEC. SB/S.B.	SPECIFICATION SPLASH BLOCK
SQ / SQ.	SQUARE
SF / S.F.	SQUARE FOOT / SUPPLY FAN
SS/S.S.	STAINLESS STEEL
ST / ST.	STAIRS
STD / STD.	STANDARD
STL/STL.	STEEL
STOR / STOR.	STORAGE
SD / S.D.	STORM DRAIN / SMOKE DETECTOR
STRUC. / STRUCT.	STRUCTURAL / STRUCTURE
SUSP / SUSP.	SUSPEND (ED)
т	
TV / TV.	TELEVISION
TEMP / TEMP.	TEMPORARY / TEMPERATURE
TERM / TERM.	TERMINATE
TPO / T.P.O.	THERMOPLASTIC POLYOLEFIN
THK / THK.	THICK
TLT / TLT.	TOILET
T&G	TONGUE AND GROOVE
Т.О.	TOP OF
TOC / T.O.C.	TOP OF CURB (CONCRETE)
TOS / T.O.S.	TOP OF STEEL
TOW / T.O.W.	TOP OF WALL
TJI / T.J.I.	TRUSS JOIST / I-JOIST
TYP / TYP.	TYPICAL
U	
UGND / UGND.	UNDERGROUND
UL/U.L.	UNDERWRITER'S LABORATORIES
UNO / U.N.O.	UNLESS NOTED OTHERWISE
01070.11.0.	UNLESS NOTED OTHERWISE
V	
VTR / V.T.R.	VENT THROUGH ROOF
VIF / V.I.F.	VERIFY IN FIELD
VERT / VERT.	VERTICAL
VEST / VEST.	VESTIBULE
w	
WC / W.C.	WATER CLOSET / WALL COVERING / WHEELCHAIR
WC / W.C. WH / W.H.	WATER CLOSET / WALL COVERING / WHEELCHAIR
WH / W.H. WT / W.T.	WEIGHT / WINDOW TREATMENT
WWF / W.W.F.	WEIGHT / WINDOW TREATMENT
WWM / W.W.M.	
WNDW / WN	WINDOW
W/	WITH
W/O	WITHOUT
WD / WD.	WOOD
X, Y, & Z	
YD / YD.	YARD

GENERAL NOTES


- DRAWINGS AND SPECIFICATIONS SHALL REMAIN THE PROPERTY OF THE ARCHITECT AND MAY NOT BE REPRODUCED IN ANY MANNER WITHOUT EXPRESSED WRITTEN CONSENT.
- ALL SUBSTITUTIONS AND CHANGES TO THESE DRAWINGS MUST BE SUBMITTED TO THE ARCHITECT FOR APPROVAL.
- . THE GENERAL CONTRACTOR SHALL INVESTIGATE ALL FIELD CONDITIONS RELEVANT TO THE PROJECT, INCLUDING BUT NOT LIMITED TO DIMENSIONS, ELEVATIONS, GENERAL CONDITIONS AND OTHER MISCELLANEOUS EXISTING CONDITIONS AND SHALL PROMPTLY NOTIFY THE ARCHITECT OF ANY WHICH DO NOT AGREE WITH THOSE IN THESE DRAWINGS.
- . THE GENERAL CONTRACTOR IS RESPONSIBLE FOR SUPPLYING AND INSTALLING ALL COMPONENTS AND ACCESSORIES, EQUIPMENT, MATERIALS, HARDWARE, AND OTHER ITEMS NECESSARY (UNLESS NOTED OTHERWISE) FOR A COMPLETE AND FINISHED JOB CONSISTENT WITH THE DESIGN INTENT PRESENTED IN THESE DRAWINGS.
- THE GENERAL CONTRACTOR IS RESPONSIBLE FOR OBTAINING ALL THE APPLICABLE BUILDING PERMITS.
- THE GENERAL CONTRACTOR IS RESPONSIBLE FOR COMPLIANCE WITH ALL CODES AND REGULATIONS ADOPTED BY THE AUTHORITIES HAVING JURISDICTION OVER THE LOCATION OF THE PROJECT, WHICH ARE APPLICABLE AT THE TIME OF ISSUANCE OF THE BUILDING PERMITS.
- THE GENERAL CONTRACTOR SHALL NOT REPRODUCE ANY PORTION OF THE CONTRACT DRAWINGS FOR USE IN ANY PORTION OF A SUBMITTAL.
- . TERMS AND ABBREVIATIONS SHOWN ON THIS SHEET FOLLOW INDUSTRY STANDARDS. TERMS AND ABBREVIATIONS MAY DIFFER ON DRAWING SHEETS AND SHALL FOLLOW THE ASSOCIATED SHEET LEGENDS U.N.O. CONTACT ARCHITECT IF ANY ABBREVIATIONS ARE NOT CLEAR.
- . MATERIAL SYMBOLS LEGEND SHOWN ON THIS SHEET FOLLOWS INDUSTRY STANDARDS. MATERIAL SYMBOLS MAY DIFFER ON DRAWING SHEETS AND SHALL FOLLOW THE ASSOCIATED SHEET LEGENDS U.N.O.
- 10. GRAPHIC AND WRITTEN INFORMATION ON DRAWINGS SHALL BE COORDINATED WITH ALL TRADES PRIOR TO INSTALLATION.
- 1. REFERENCE SPECIFICATION FOR ALL MATERIALS NOTED ON DRAWINGS.
- 12. THE GENERAL CONTRACTOR SHALL COORDINATE ACCESS TO/AND STORAGE ON SITE WITH THE OWNER, THE GENERAL CONTRACTOR SHALL ALSO REPAIR DAMAGE TO ALL ADJACENT AREAS OCCURRING DURING CONSTRUCTION. THE GENERAL CONTRACTOR WILL BE RESPONSIBLE FOR THE REMOVAL OF ALL EXCESS TRASH AND OTHER MISCELLANEOUS MATERIALS FROM THE SITE
- 13. PATCH ALL FLOORS, WALLS AND CEILINGS ALTERED DURING CONSTRUCTION AS REQUIRED TO MATCH EXISTING. PATCH ANCHOR HOLES IN MASONRY WALL WHERE ACCESSORIES HAVE BEEN MOVED AND/OR OMITTED.
- 14. IN ALL EXISTING AREAS, RENOVATION WORK SHALL BE ACCOMPLISHED WITH MINIMAL DISRUPTION TO OPERATIONS. IF REQUIRED, THE OWNER RESERVES THE RIGHT TO TEMPORARILY STOP WORK OF SPECIFIC CONSTRUCTION OPERATIONS SHOULD THE OWNER IDENTIFY AN EMERGENCY OR DANGER EXISTS TO THE WELFARE OF THE OCCUPANTS ON ACCOUNT OF SUCH WORK OR OPERATIONS.
- 15. ERECT AND MAINTAIN DUST PARTITIONS AS REQUIRED FOR ALL PHASES OF CONSTRUCTION TO PREVENT DIRT, DUST OR WET SURFACES/FINISHES FROM ENTERING ADJACENT OCCUPIED SPACES.
- 16. SCHEDULE ALL WORK PRODUCING EXCESS NOISE OR VIBRATIONS WITH OWNER TO MINIMIZE DISRUPTION TO BUILDING TENANTS. ALL WORK FOUND TO BE DISRUPTIVE SHALL BE SUSPENDED IMMEDIATELY UPON NOTICE FROM OWNER AND RESCHEDULED IN ADVANCE TO ALLOW ADVANCE NOTICE AND ALTERNATE ACCOMMODATIONS FOR TENANTS. THE CONTRACTOR IS RESPONSIBLE FOR SCHEDULING THE WORK IN ADVANCE SO AS NOT TO DELAY THE PROGRESS OF THE WORK.
- 17. MAINTAIN ALL EXIT PATHS FOR THE DURATION OF THE CONSTRUCTION.
- 18. SCHEDULE WITH OWNER ALL WORK REQUIRING THE DISABLING OF ALL BUILDING SAFETY SYSTEMS, INCLUDING BUT NOT LIMITED TO; STANDPIPES, SPRINKLERS, FIRE ALARMS, AND SECURITY SYSTEMS. THE WORK SHALL BE SCHEDULED IN ADVANCE TO ALLOW ADVANCE NOTICE AND ALTERNATE ACCOMMODATIONS FOR TENANTS. THE CONTRACTOR IS RESPONSIBLE FOR SCHEDULING THE WORK IN ADVANCE SO AS NOT TO DELAY THE PROGRESS OF THE WORK.
- 9. SCHEDULE WITH OWNER ALL UTILITY SHUTDOWNS AFFECTING AREAS OF THE BUILDING BEYOND THE PROJECT LIMITS OF WORK. THE WORK SHALL BE SCHEDULED IN ADVANCE TO ALLOW ADVANCE NOTICE AND ALTERNATE ACCOMMODATIONS FOR TENANTS. THE CONTRACTOR IS RESPONSIBLE FOR SCHEDULING THE WORK IN ADVANCE SO AS NOT TO DELAY THE PROGRESS OF THE WORK.
- 20. ERECT AND MAINTAIN APPROPRIATE SAFETY BARRIERS AND PATHWAYS TO PROTECT AND SEPARATE PUBLIC/TENANTS FROM HAZARDOUS CONDITIONS. BARRIERS SHALL BE MAINTAINED THROUGH DURATION OF THE PROJECT TO PROHIBIT UNAUTHORIZED PERSONNEL FROM ENTERING THE CONSTRUCTION AREA/SITE.
- 21. OWNER SHALL BE RESPONSIBLE FOR RELOCATION, INSTALLATION AND STORAGE OF EXISTING FURNITURE.
- 22. CONTRACTOR SHALL NOT REPRODUCE ANY PORTION OF A CONTRACT DRAWING FOR USE IN ANY PORTION OF A SUBMITTAL.
- 23. ALL DIMENSIONS ARE FROM THE FACE OF STUD FRAMING, FACE OF MASONRY, FACE OF CONCRETE, OR CENTER LINE OF STRUCTURAL STEEL, U.N.O..
- 24. ALL DOORS ARE LOCATED 6 INCHES FROM THE R.O. TO THE ADJACENT PERPENDICULAR STUD WALL FRAMING AND 8 INCHES FROM THE ADJACENT PERPENDICULAR CMU WALL FRAMING TO THE HINGE SIDE OF THE DOOR OPENING, U.N.O..
- 25. COORDINATE THE LOCATION AND INSTALLATION OF ALL MECHANICAL AND ELECTRICAL DEVICES, REGISTERS, FIXTURES, ETC. PRIOR TO INSTALLATION OF FINISH MATERIAL.
- 26. ALL A.D.A. ACCESSIBLE WATER CLOSETS MUST BE LOCATED 18 INCHES MINIMUM FROM THE FINISHED FACE OF THE NEAREST ADJACENT WALL TO THE CENTER LINE OF THE FIXTURE, U.N.O...
- 27. PROVIDE CONTROL JOINTS ON CONTINUOUS GYPSUM BOARD SURFACES IN EXCESS OF 30'-0", AT A MAXIMUM INCREMENT OF 30'-0" ON CENTER, U.N.O.
- 28. PROVIDE SEALANT IN FLOOR JOINTS OF EXPOSED FINISHES PER FLOOR COATING MANUFACTURER'S RECOMMENDATIONS.
- 29. SEE SHEET A-601 FOR PARTITION TYPES; SEE ARCHITECTURAL FLOOR PLANS FOR ADDITIONAL PARTITION IDENTIFICATION.
- 30. REFER TO STRUCTURAL NOTES FOR ALL CAST-IN-PLACE CONCRETE AND MASONRY CONTROL JOINTS.

SHEET INDEX						
	SHEET		REVISION			
###	NUMBER	SHEET NAME	NO.			
1 [G] GEI	NERAL					
)1	G-001	COVER SHEET				
)2	G-002	SHEET INDEX				
)3	G-101	CODE NARRATIVE AND PLANS				
3 [A] ARC	CHITECTURAL					
)4	A-101	ARCHITECTURAL PLANS AND DETAILS				
4 [MP] M	ECHANICAL/PLUMB	NG				
)5	MP-201	MECHANICAL PLANS				
5 [E] ELE	CTRICAL					
06	E-101	ELECTRICAL FLOOR PLAN, ELEVATOR DETAIL, RISER				

GRAPHIC SYMBOLS LEGEND

C4

NO

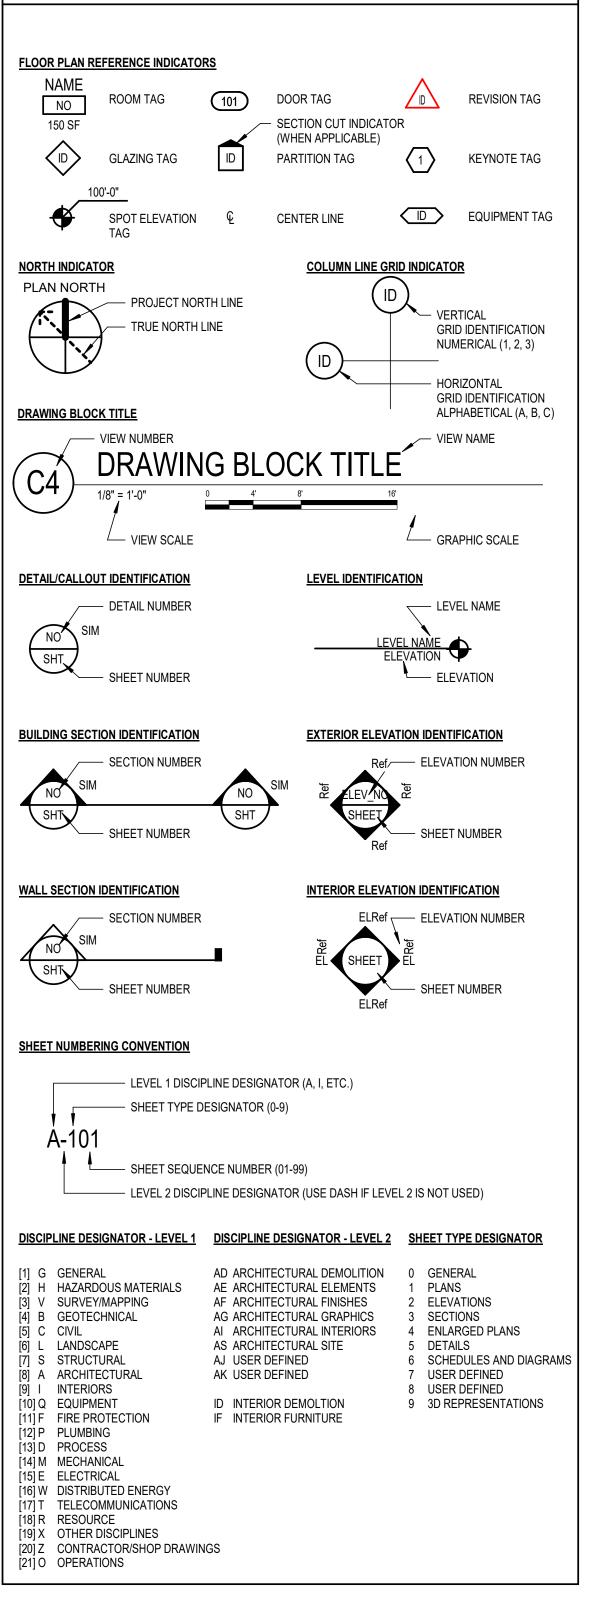





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\triangle	DESCRIPTION	DATE
PROJEC	T NO:	00939R25001
STATUS:	CEF	RTIFIED FINAL
DATE:		6/12/2025
DRAWN I	BY:	CGK
CHECKE	D BY:	NLK

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SHEET INDEX



AUTHORITY HAVING JURI		OCAL: METROPOLITAN AREA AND E CONSTRUCTION DEPARTME 271 W. 3RD STREET N. WICHITA, KS 67202 TEL: (316) 660-1840 TATE: KANSAS STATE FIRE MARSH	NT (MABCD)
CODE BUILDING CODE	TITLE INTERNATIONAL BUI		EDITION 2024
EXIST. BUILDING CODE EXIST. BUILDING CODE MECHANICAL CODE	INTERNATIONAL EXIS	LDING CODE (IBC) STING BUILDING CODE (IEBC) CHANICAL CODE (IMC)	2024 2024 2024
PLUMBING CODE ELECTRICAL CODE	UNIFORM PLUMBING		2021 2023
FIRE PREVENTION ELEVATORS	INTERNATIONAL FIRE ASME A17.1-2022 SAF		2018 2022
USE AND OCCUPANCY:	ESCALATORS		
USE GROUP GROUP S-2	OCCUPANCY CLASS	IFICATION AGE (PUBLIC PARKING GARAGE)	IBC Sect 311
GENERAL BUILDING HEIC	GHTS AND AREAS:		IBC
Building Height Type IIB	ALLOWABLE(FT) 55 FT	ACTUAL(FT) UNCHANGED	Table 504
	3 STORIES		IBC Sect 506 C
BUILDING AREA TYPE IIB	ALLOWABLE(SF) 39,000 SF	ACTUAL(SF) UNCHANGED	Sect 506.2
CONSTRUCTION CLASSI TYPE II-B	FIGATION		IBC Table 601
		SISTANCE RATING (HR)	IBC Table 601
PRIMARY STRUCTURAL F BEARING WALLS EXTERIOR	RAME	0 0	
INTERIOR NONBEARING WALLS & P	PARTITIONS	0	
EXTERIOR INTERIOR FLOOR CONSTRUCTION /		SEE TABLE 705.5 0	
FLOOR CONSTRUCTION A ASSOCIATED SECONDAF ROOF CONSTRUCTION A	RYMEMBERS	0	
ASSOCIATED SECONDAF	RYMEMBERS	0 R EXTERIOR WALLS BASED ON EIR	
FIRE-RESISTANCE RATIN DISTANCE FIRE SEPARATION DISTA		R EXTERIOR WALLS BASED ON FIR	E SEPARATION IBC
FIRE SEPARATION DISTA 705.5		OCCUPANCY GROUP S	Table
X ≥ 30 FIRE AND SMOKE PROTE		0 HOUR	
FIRE AND SMOKE PROTE FIRE BARRIERS			IBC
OCCUPANCY GROUP S-2	FIRE-RES	SISTANCE RATING (HR) 2	Table 707.3.10
PENETRATIONS THROUGH FIRE-RESISTA		NS	IBC Sect 714.3
OPENING PROTECTIVES	FIRE-RESIST.	ANCE RATING (HR)	IBC
FIRE DOOR RATINGS	FIRE BARRIE		Table 716.1(2)
FIRE PROTECTION SYSTI	EMS:	RS = 3/4 HR	
FIRE PROTECTION SYSTI PORTABLE FIRE EXTING CLASS 'A' FIRE CLASSIFIC	UISHERS	RS = 3/4 HR	IBC Table 906.3(1)
PORTABLE FIRE EXTING CLASS 'A' FIRE CLASSIFIC LIGHT' HAZARD OCCUPA EXTINGUISHER RATING:	UISHERS CATION NCY		IBC Table 906.3(1)
PORTABLE FIRE EXTING CLASS 'A' FIRE CLASSIFIC LIGHT' HAZARD OCCUPA EXTINGUISHER RATING: MINIMUM RATING: MAX. FLOOR AREA MAX. FLOOR AREA	UISHERS CATION NCY / UNIT OF 'A': 3 / EXTINGUISHER: 1 ANCE TO EXITING.: 7		IBC Table 906.3(1)
PORTABLE FIRE EXTING CLASS 'A' FIRE CLASSIFIC LIGHT' HAZARD OCCUPA EXTINGUISHER RATING: MINIMUM RATING: MAX. FLOOR AREA MAX. FLOOR AREA MAX. TRAVEL DISTA PROVIDED: FIRE ALARM AND DETEC GROUP S-2	UISHERS CATION INCY / UNIT OF 'A': 2 / EXTINGUISHER: 1 ANCE TO EXITING.: 7 [2 TION SYSTEMS	2-A N 3,000 SF 11,250 SF 75 FEET 2A-10B:C, 5 LBS]	IBC Table 906.3(1)
PORTABLE FIRE EXTING CLASS 'A' FIRE CLASSIFIC LIGHT' HAZARD OCCUPA EXTINGUISHER RATING: MINIMUM RATING: MAX. FLOOR AREA MAX. FLOOR AREA MAX. TRAVEL DISTA PROVIDED: FIRE ALARM AND DETEC	UISHERS CATION INCY / UNIT OF 'A': 2 / EXTINGUISHER: 1 ANCE TO EXITING.: 7 [2 TION SYSTEMS	2-A N 3,000 SF 11,250 SF 75 FEET 2A-10B:C, 5 LBS]	IBC Table 906.3(1) FPA 10-Table 6.2.1.1 IBC
PORTABLE FIRE EXTING CLASS 'A' FIRE CLASSIFIC LIGHT' HAZARD OCCUPA EXTINGUISHER RATING: MINIMUM RATING: MAX. FLOOR AREA MAX. FLOOR AREA MAX. TRAVEL DISTA PROVIDED: FIRE ALARM AND DETEC GROUP S-2 EXISTING (UNCHANG MEANS OF EGRESS: FUNCTION OF SPACE	UISHERS CATION NCY / UNIT OF 'A': 3 / EXTINGUISHER: 1 ANCE TO EXITING.: 7 ION SYSTEMS ED)	2-A N 3,000 SF 11,250 SF 75 FEET 2A-10B:C, 5 LBS]	IBC Table 906.3(1) FPA 10-Table 6.2.1.1 IBC
PORTABLE FIRE EXTING CLASS 'A' FIRE CLASSIFIC LIGHT' HAZARD OCCUPA EXTINGUISHER RATING: MINIMUM RATING: MAX. FLOOR AREA. MAX. FLOOR AREA. MAX. TRAVEL DISTA PROVIDED: FIRE ALARM AND DETEC GROUP S-2 EXISTING (UNCHANG MEANS OF EGRESS: FUNCTION OF SPACE TOTAL OCCUPANT LOAD	UISHERS CATION NCY / UNIT OF 'A': 3 / EXTINGUISHER: 1 ANCE TO EXITING.: 7 ION SYSTEMS ED) UNCHANGED	2-A N 3,000 SF 11,250 SF 75 FEET 2A-10B:C, 5 LBS] Sect 907.2	IBC Table 906.3(1) FPA 10-Table 6.2.1.1 IBC
PORTABLE FIRE EXTING CLASS 'A' FIRE CLASSIFIC LIGHT' HAZARD OCCUPA EXTINGUISHER RATING: MINIMUM RATING: MAX. FLOOR AREA. MAX. FLOOR AREA. MAX. TRAVEL DISTA PROVIDED: FIRE ALARM AND DETEC GROUP S-2 EXISTING (UNCHANG MEANS OF EGRESS: FUNCTION OF SPACE TOTAL OCCUPANT LOAD MEANS OF EGRESS SIZIN STAIRWAYS: 0.3 INCHES PER OCC	UISHERS CATION NCY / UNIT OF 'A': 3 / EXTINGUISHER: 1 ANCE TO EXITING.: 7 [2 TION SYSTEMS ED) UNCHANGED NG CUPANT	2-A N 3,000 SF 11,250 SF 75 FEET 2A-10B:C, 5 LBS] Sect 907.2	IBC Table 906.3(1) FPA 10-Table 6.2.1.1 <u>IBC</u> <u>IBC</u> <u>IBC</u> <u>Sect 1005.3.1</u>
PORTABLE FIRE EXTING CLASS 'A' FIRE CLASSIFIC LIGHT' HAZARD OCCUPA EXTINGUISHER RATING: MINIMUM RATING: MAX. FLOOR AREA. MAX. FLOOR AREA. MAX. TRAVEL DISTA PROVIDED: FIRE ALARM AND DETEC GROUP S-2 EXISTING (UNCHANG MEANS OF EGRESS: FUNCTION OF SPACE TOTAL OCCUPANT LOAD MEANS OF EGRESS SIZIN STAIRWAYS:	UISHERS CATION NCY / UNIT OF 'A': 3 / EXTINGUISHER: 1 ANCE TO EXITING.: 7 [2 TION SYSTEMS ED) UNCHANGED NG CUPANT NENTS:	2-A N 3,000 SF 11,250 SF 75 FEET 2A-10B:C, 5 LBS] Sect 907.2	IBC Table 906.3(1) FPA 10-Table 6.2.1.1 IBC IBC
PORTABLE FIRE EXTING CLASS 'A' FIRE CLASSIFIC LIGHT' HAZARD OCCUPA EXTINGUISHER RATING: MINIMUM RATING: MAX. FLOOR AREA. MAX. FLOOR AREA. MAX. TRAVEL DISTA PROVIDED: FIRE ALARM AND DETEC GROUP S-2 EXISTING (UNCHANG MEANS OF EGRESS: FUNCTION OF SPACE TOTAL OCCUPANT LOAD MEANS OF EGRESS SIZIN STAIRWAYS: 0.3 INCHES PER OCC OTHER EGRESS COMPOI 0.2 INCHES PER OCC	UISHERS CATION NCY / UNIT OF 'A': 3 / EXTINGUISHER: 1 ANCE TO EXITING.: 7 I ANCE TO EXIT I ANCE TO EXI	2-A N 3,000 SF 11,250 SF 75 FEET 2A-10B:C, 5 LBS] Sect 907.2	IBC Table 906.3(1) FPA 10-Table 6.2.1.1 IBC IBC IBC Sect 1005.3.1
PORTABLE FIRE EXTING CLASS 'A' FIRE CLASSIFIC LIGHT' HAZARD OCCUPA EXTINGUISHER RATING: MINIMUM RATING: MAX. FLOOR AREA. MAX. FLOOR AREA. MAX. TRAVEL DISTA PROVIDED: FIRE ALARM AND DETEC GROUP S-2 EXISTING (UNCHANG MEANS OF EGRESS: FUNCTION OF SPACE TOTAL OCCUPANT LOAD MEANS OF EGRESS SIZIN STAIRWAYS: 0.3 INCHES PER OCC OTHER EGRESS COMPOI 0.2 INCHES PER OCC COMMON PATH OF EGRE OCCUPANCY GROUP GROUP 'S' EXIT AND EXIT ACCESS E	UISHERS CATION NCY / UNIT OF 'A': 3 / EXTINGUISHER: 1 ANCE TO EXITING.: 7 [2 TION SYSTEMS ED) CUPANT NENTS: CUPANT NENTS: CUPANT SS TRAVEL WITHOUT ALLOWABLE(ft) 75 FT DOOR	2-A N 3,000 SF 11,250 SF 75 FEET 2A-10B:C, 5 LBS] Sect 907.2 CCUPANT LOAD FACTOR SPRINKLER SYSTEM ACTUAL(ft) UNCHANGED	IBC Table 906.3(1) FPA 10-Table 6.2.1.1 PPA 10-Table 6.2.1.1 IBC IBC IBC Sect 1005.3.1 Sect 1005.3.2 IBC Table 1006.2 IBC
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CODE NARRATIVE - K.A.R. 22-1-7

BUILDING PROJECT TYPE: (2) ELEVATOR REPLACEMENTS

PROJECT DESCRIPTION THIS PROJECT IS TO MODERNIZE AND REPLACE EQUIPMENT FOR TWO ELEVATORS IN ONE OF THE PARKING GARAGES OWNED BY SEDGWICK COUNTY.

OWNER: SEDGWICK COUNTY

FACILITY NAME: SEDGWICK COUNTY PARKING GARAGE

DESIGNERS:

RCHITECT:	MECHANICAL AND ELECTRICAL ENGINEERS:
ESSERE	INTEGRATED CONSULTING ENGINEERS, INC.
525 E. DOUGLAS	349 SOUTH HYDRAULIC
ICHITA, KS 67211	WICHITA, KS 67211
(316) 265-9367	P: (316) 264-3588
(316) 265-5646	

THE INFORMATION REPRESENTED ON THE FOLLOWING DRAWINGS RESPOND TO REQUIREMENTS OF K.A.R. 22-1-7 CODE FOOTPRINT.

THE DRAWINGS LISTED BELOW RESPOND TO K.A.R. 22-1-7 (a) and (b):

- G-101 CODE NARRATIVE AND PLANS
- **NO ANTICIPATED FUTURE ADDITIONS**

THE FOLLOWING NARRATIVE RESPOND TO K.A.R. 22-1-7 (c):


- (1) PROJECT CONSTRUCTION PURPOSE: REPLACEMENT OF EXISTING ELEVATORS (2) REASON FOR SUBMITTAL: RENOVATION
- (3) APPLICABLE CODES: 2024 INTERNATIONAL BUILDING CODE (IBC)
 - 2024 INTERNATIONAL EXISTING BUILIDING CODE (IEBC)
 - 2018 INTERNATIONAL FIRE CODE (IFC) 2021 UNIFORM PLUMBING CODE (UPC)
 - 2024 INTERNATIONAL MECHANICÀL CÓDE (IMC)
- 2023 NFPA 70 NATIONAL ELECTRIC CODE ASME 117.1-2022 - SAFETY CODE FOR ELEVATORS AND ESCALATORS
- KANSAS FIRE PREVENTION CODE (4) BUILDING LOCATION:
- 603 N. MAIN STREET, WICHITA, KS 67203
- (5) OWNER:

THE PROJECT IS BEING ADMINISTERED BY SEDGWICK COUNTY SANDY ANGUELOV 271 W. 3RD STREET SUITE 325

- WICHITA, KS 67202
- OFFICE: (316) 660-9853 CELL: (206) 234-5434
- (6) DATES: DATES AND REVISIONS ARE SHOWN ON THE SHEET TITLE BLOCK
- (7) DESIGNER'S INFORMATION: SHOWN ABOVE AND ON THE SHEET TITLE BLOCK
- (8) DESIGNERS SEAL: AFFIXED TO THE SHEET TITLE BLOCK
- (9) RESPONDING FIRE SERVICE: CITY OF WICHITA DEPARTMENT
 - 731 N MAIN
- WICHITA, KS 67203
- (10) LOCAL BUILDING INSPECTION DEPARTMENT: METROPOLITAN AREA BUILDING AND CONSTRUCTION DEPARTMENT
- (MABCD) 271 WE. 3RD STREET N.
- WICHITA, KS 67202
- OFFICE: (316) 660-1840 (11) OCCUPANCY GROUP AND TYPE:
- OCCUPANCY GROUP: S-2
- (12) TYPE OF CONSTRUCTION: II-B ASSUMED

CODE PLAN	LEGEND
	2-HOUR FIRE BARRIER; IBC SECTION 707 (OCCUPANCY SEPARATION) 90-MIN. RATED DOOR ASSEMBLY. FIRE DAMPERS.
®	FIRE DOOR ASSEMBLY RATING
FH	FIRE HYDRANT DISTANCE FROM BUILDING SHOWN ON SITE PLAN
NAME 101 100SF 100/OCC 1 OCC	ROOM NAME ROOM NUMBER (OMITTED AT AREAS) AREA OF ROOM OR AREA OCCUPANT LOAD FACTOR NUMBER OF OCCUPANTS

SHEE I FLOT

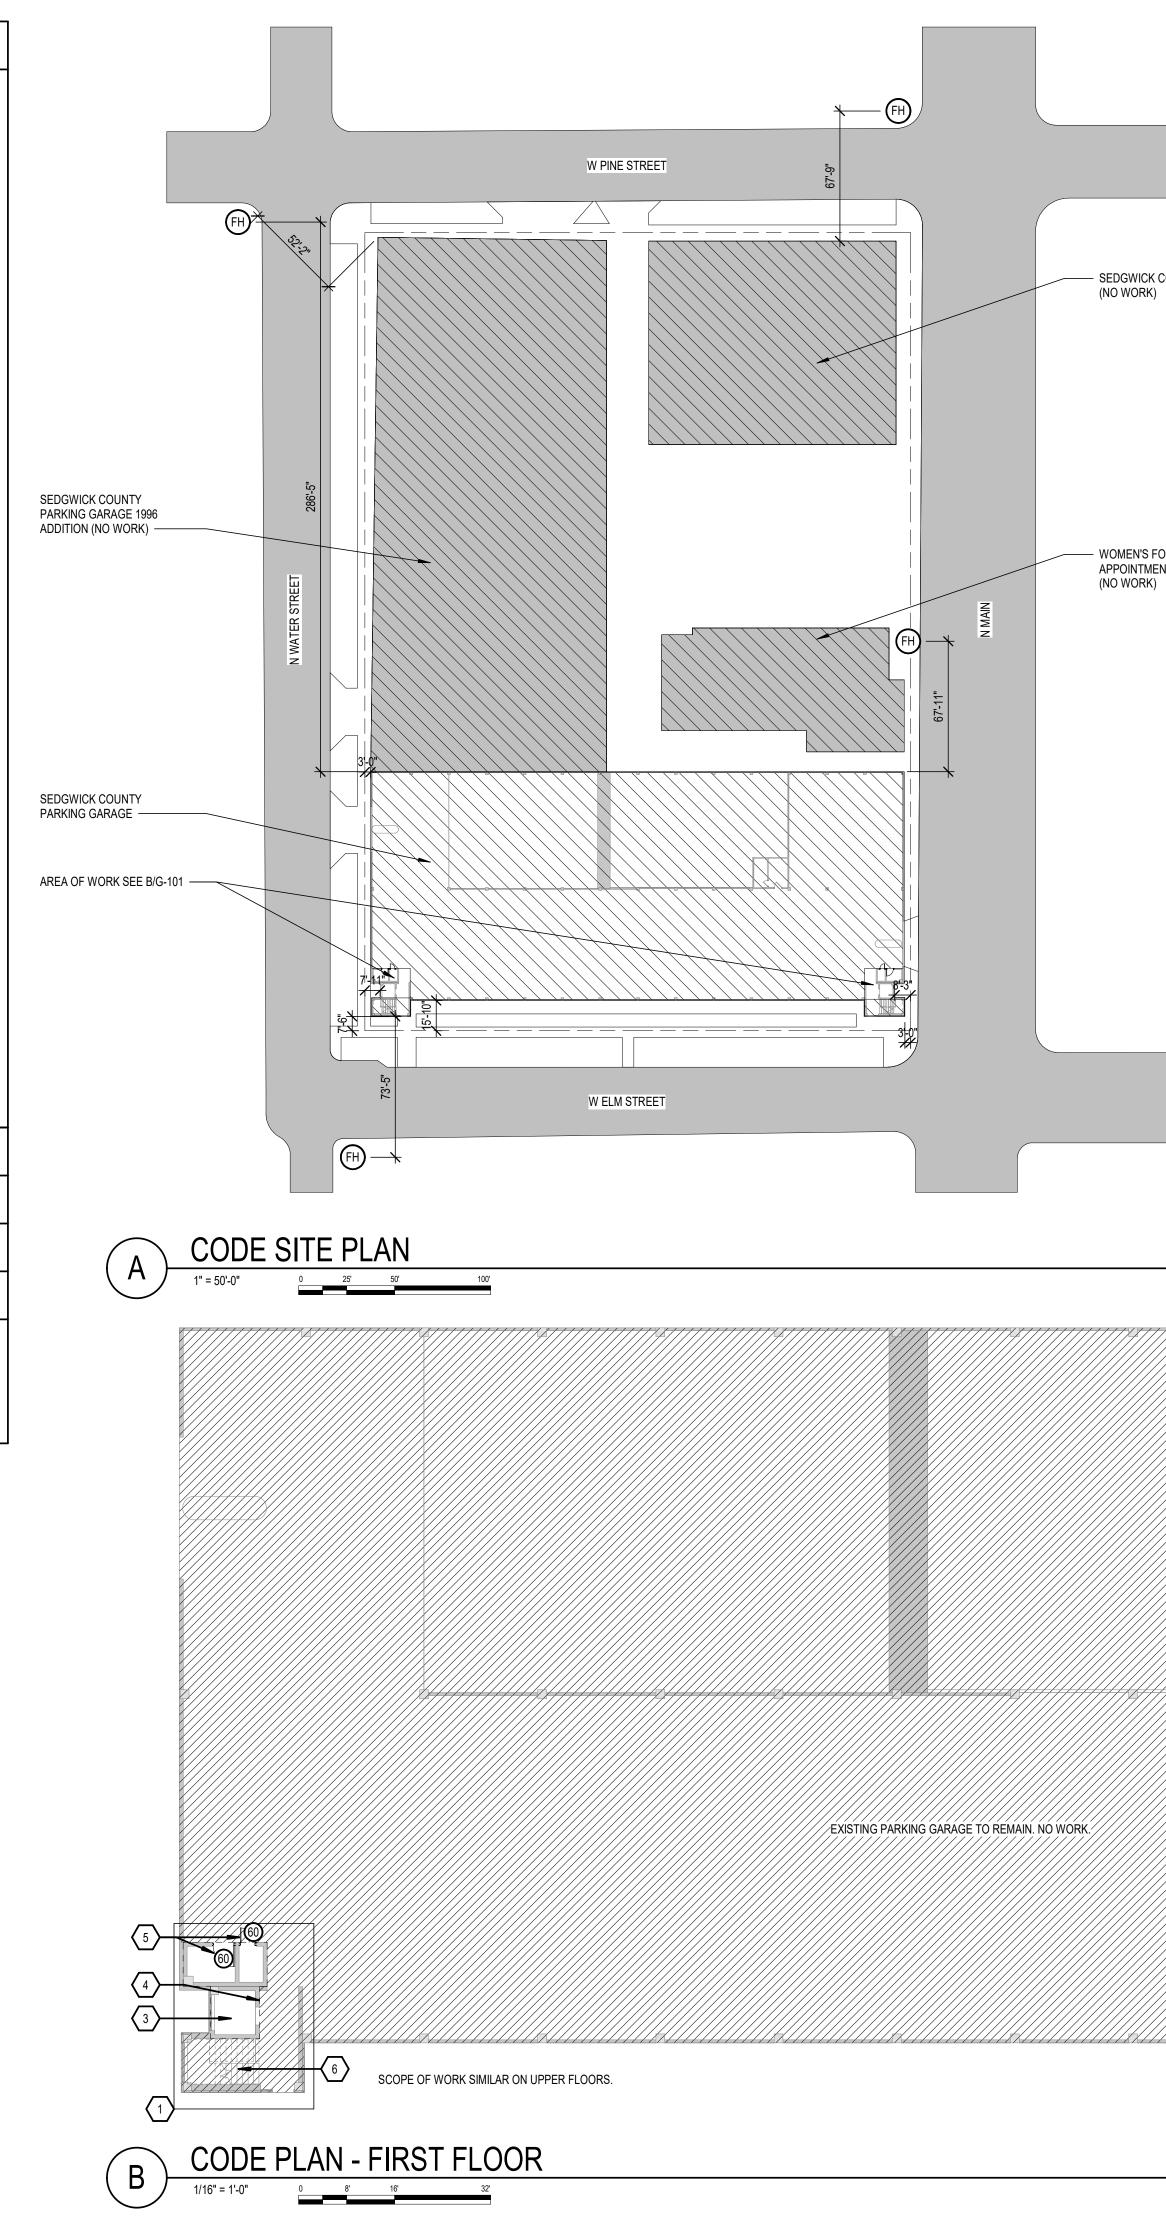

SEDGWICK COUNTY BILLING (NO WORK)

SHEET KEYNOTES

DESCRIPTION # | 1 PHASE 1: WEST ELEVATOR AND SUPPORTING ROOMS

ADD01

 2
 PHASE 2: EAST ELEVATOR AND SUPPORTING ROOMS

 3
 ELEVATOR CAB TO REMAIN. DEMO AND REPLACE FLOOR FINISH, WALL PANELS, TRIM,

 RAILING AND GLASS
 NEW ELEVATOR COMMUNICATION TO BE INSTALLED AT ALL LEVELS AT EACH CAR IN COMPLIANCE WITH IBC SECTION 3001.2 TO MEET IEBC SECTION 306.7.7.
 DEMO EXISTING DOORS AND REPLACE WITH NEW 1HR FIRE RATED DOORS. 6 EXISTING STAIRS TO REMAIN. NOT PART OF PROJECT SCOPE.

WOMEN'S FOUNDATION APPOINTMENTS PROJECT



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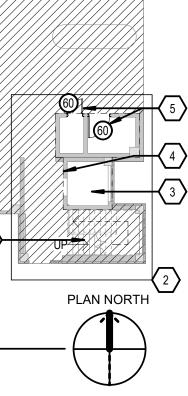
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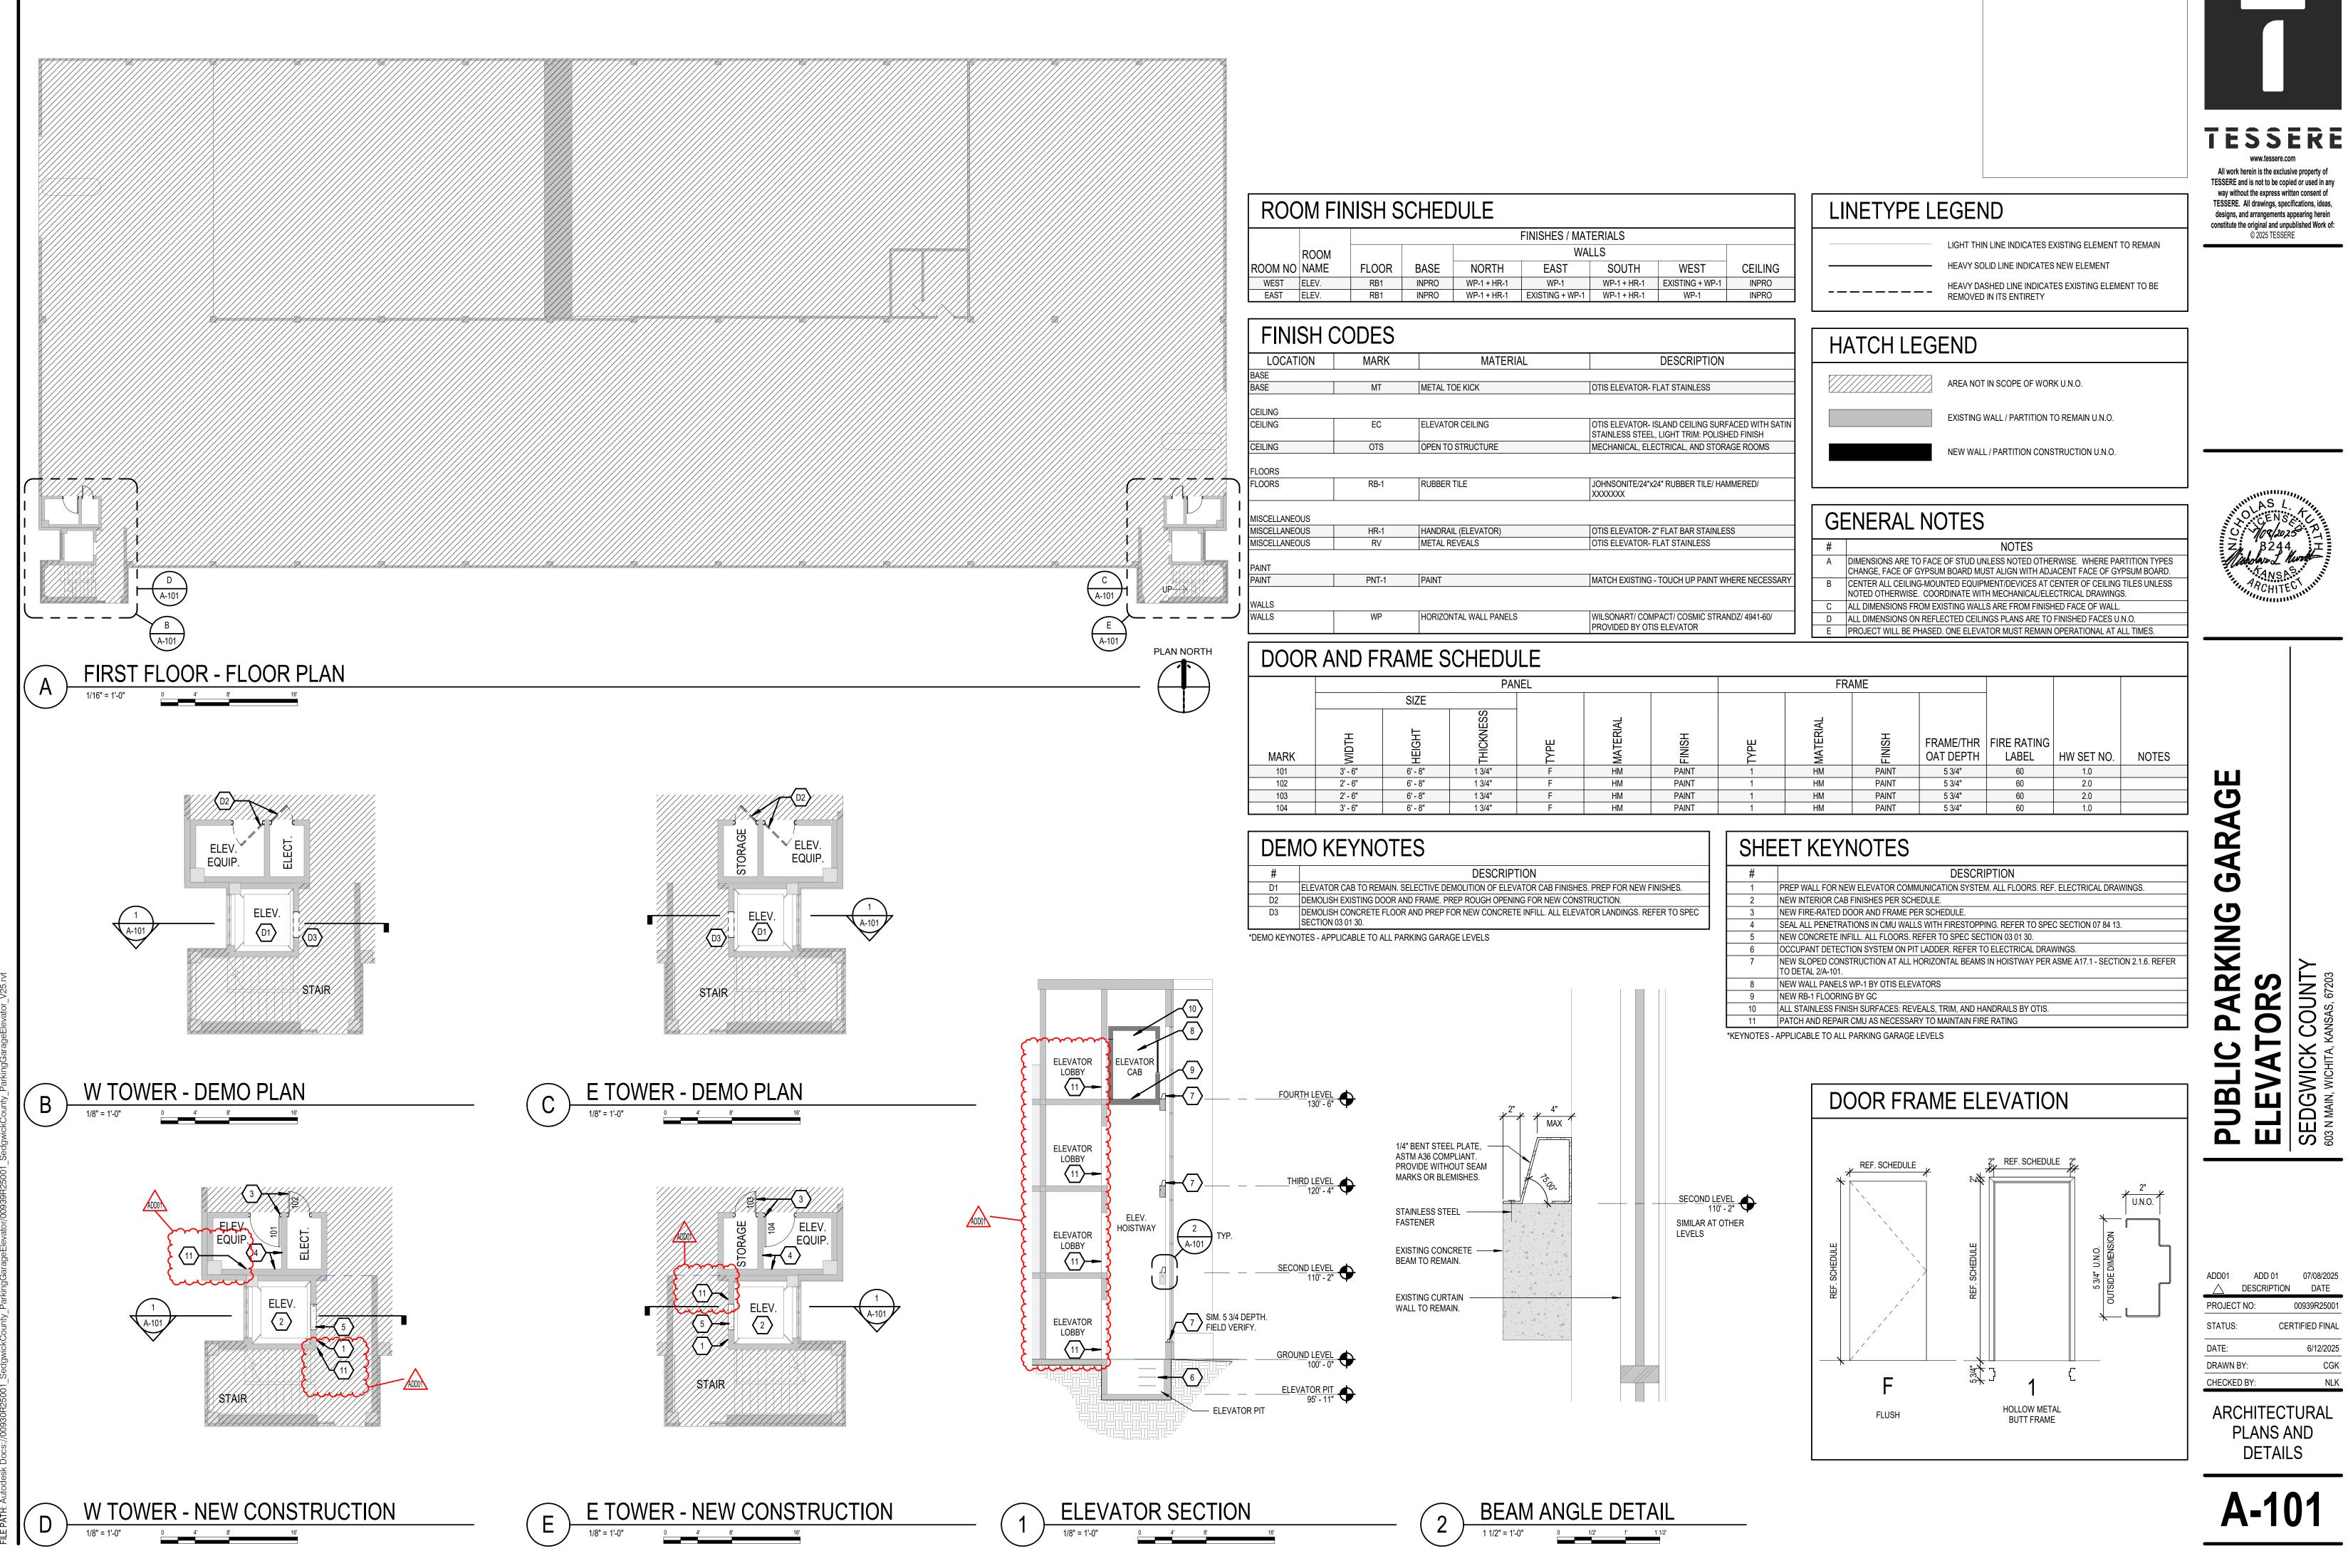
ADD01	ADD 01 DESCRIPTIO	07/08/2025 N DATE
PROJEC	T NO:	00939R25001
STATUS	: CE	ERTIFIED FINAL
DATE:		6/12/2025
DRAWN	BY:	CGK
CHECKE	ED BY:	NLK

ш

CODE NARRATIVE AND PLANS









			FINISHES / I									
	ROOM				WA	LLS						
ROOM NO	NAME	FLOOR	BASE	NORTH	EAST	SOL						
WEST	ELEV.	RB1	INPRO	WP-1 + HR-1	WP-1	WP-1						
EAST	ELEV.	RB1	INPRO	WP-1 + HR-1	EXISTING + WP-1	WP-1						

LOCATION	MARK	MATERIAL	
BASE			
BASE	MT	METAL TOE KICK	OTIS ELE
CEILING			
CEILING	EC	ELEVATOR CEILING	OTIS ELE STAINLES
CEILING	OTS	OPEN TO STRUCTURE	MECHAN
FLOORS			
FLOORS	RB-1	RUBBER TILE	JOHNSON XXXXXXX
MISCELLANEOUS			
MISCELLANEOUS	HR-1	HANDRAIL (ELEVATOR)	OTIS ELE
MISCELLANEOUS	RV	METAL REVEALS	OTIS ELE
PAINT			
PAINT	PNT-1	PAINT	MATCH E
WALLS			
WALLS	WP	HORIZONTAL WALL PANELS	WILSONA


			PA	NEL				FRA	AME				
		SIZE											
MARK	WIDTH	НЕІСНТ	THICKNESS	ТҮРЕ	MATERIAL	FINISH	ТҮРЕ	MATERIAL	FINISH	FRAME/THR OAT DEPTH	FIRE RATING LABEL	HW SET NO.	NOTES
101	3' - 6"	6' - 8"	1 3/4"	F	HM	PAINT	1	HM	PAINT	5 3/4"	60	1.0	
102	2' - 6"	6' - 8"	1 3/4"	F	HM	PAINT	1	HM	PAINT	5 3/4"	60	2.0	
103	2' - 6"	6' - 8"	1 3/4"	F	HM	PAINT	1	HM	PAINT	5 3/4"	60	2.0	
104	3' - 6"	6' - 8"	1 3/4"	F	HM	PAINT	1	HM	PAINT	5 3/4"	60	1.0	

	#	DESCRIPTION							
IES.	1 PREP W	ALL FOR NEW ELEVATOR COMMUNICATION SYSTEM. ALL FLOORS. REF. ELECTRICAL DRAWINGS.							
	2 NEW INT	ERIOR CAB FINISHES PER SCHEDULE.							
O SPEC	3 NEW FIR	E-RATED DOOR AND FRAME PER SCHEDULE.							
	4 SEAL AL	L PENETRATIONS IN CMU WALLS WITH FIRESTOPPING. REFER TO SPEC SECTION 07 84 13.							
	5 NEW CO	NCRETE INFILL. ALL FLOORS. REFER TO SPEC SECTION 03 01 30.							
	6 OCCUPA	NT DETECTION SYSTEM ON PIT LADDER. REFER TO ELECTRICAL DRAWINGS.							
		DPED CONSTRUCTION AT ALL HORIZONTAL BEAMS IN HOISTWAY PER ASME A17.1 - SECTION 2.1.6. REFER AL 2/A-101.							
	8 NEW WA	ALL PANELS WP-1 BY OTIS ELEVATORS							
		RB-1 FLOORING BY GC							
		INLESS FINISH SURFACES: REVEALS, TRIM, AND HANDRAILS BY OTIS.							
	11 PATCH A	ND REPAIR CMU AS NECESSARY TO MAINTAIN FIRE RATING							
		3LE TO ALL PARKING GARAGE LEVELS							
		DOOR FRAME ELEVATION							
		REF. SCHEDULE 2"							

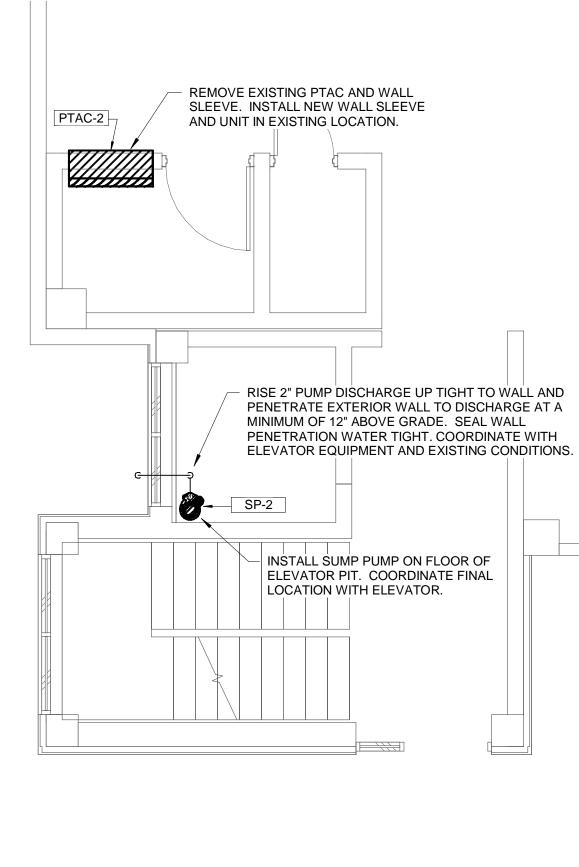

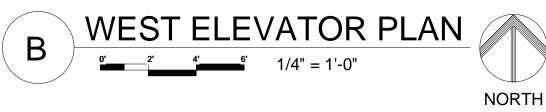



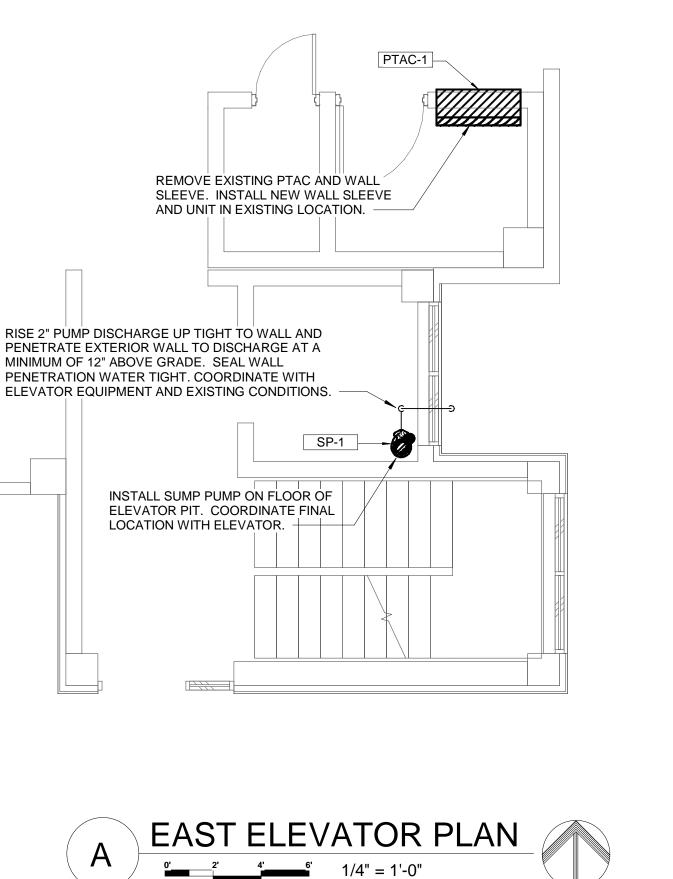

NORTH

PROJECT MECHANICAL DESI

PROJECT CITY: WICHITA, KANSAS **DESIGN WEATHER ST** PROJECT ELEVATION: 1321 FT. ABOVE SEA LEVEL WICHITA EISENHO

GOVERNING CODES:

- BUILDING CODE: 2024 INTERNATIONAL BUILDING CODE FIRE CODE:
- 2018 INTERNATIONAL FIRE CODE MECHANICAL CODE:
- 2024 INTERNATIONAL MECHANICAL CODE PLUMBING CODE:
- 2021 UNIFORM PLUMBING CODE FUEL GAS CODE: 2021 INTERNATIONAL FUEL GAS CODE
- ELECTRICAL CODE: 2023 NATIONAL ELECTRIC CODE

ENERGY CODE: ASHRAE 90.1-2010

MECHANICAL GENERAL NOTES

- 1. PLANS ARE SCHEMATIC IN NATURE. LAYOUT IS BASED ON BEST AVAILABLE INFORMATION. PRIOR TO SUBMITTING BID CONTRACTOR SHALL VISIT JOB SITE AND BECOME FULLY ACQUAINTED WITH EXISTING CONDITIONS OF PROJECT. NOTIFY ARCHITECT OF CONFLICTS OR DISCREPANCIES PRIOR TO SUBMISSION OF BID.
- COORDINATE INSTALLATION OF MECHANICAL SYSTEMS WITH OTHER TRADES TO ENSURE NEAT AND ORDERLY INSTALLATION. COORDINATE ACCESS TO EQUIPMENT, VALVES, AND DAMPERS INSTALLED ABOVE 'INACCESSIBLE' CEILINGS AND IN CHASES. ETC. WITH GENERAL CONTRACTOR. PROVIDE LOCKING ACCESS DOORS FOR INSTALLATION BY GENERAL CONTRACTOR AS REQUIRED TO SERVICE
- THIS CONTRACTOR AND INSTALLED BY GENERAL CONTRACTOR. / COOLING EQUIPMENT AND CONTROLS AS REQUIRED.
- 5. ALL NEW THERMOSTATS SHALL BE PLACED AT 4'-0" MAXIMUM ABOVE FINISHED FLOOR PER ADA REQUIREMENTS. VERIFY HEIGHTS WITH OWNER PRIOR TO FINAL INSTALLATION.
- COORDINATE INSTALLATION OF PLUMBING SYSTEMS WITH OTHER TRADES TO ENSURE NEAT AND ORDERLY INSTALLATION.
 FIELD MEASURE FINAL PIPING LOCATIONS PRIOR TO FABRICATION AND MAKE ADJUSTMENTS AS REQUIRED. MAINTAIN MANUFACTURER'S
- RECOMMENDATIONS REGARDING SERVICE CLEARANCE AND PROPER AIRFLOW CLEARANCE AROUND EQUIPMENT. ELEMENTS. PIPING SHALL RISE AND DROP, JOG OR OFFSET AS REQUIRED TO AVOID CONFLICTS. DUCTWORK SHALL TAKE PRECEDENCE DRAINS AS REQUIRED TO DRAIN SYSTEM.
- 9. NO PIPING SHALL PENETRATE STRUCTURAL MEMBERS. 10. DO NOT ROUTE PIPING OR DUCTWORK ABOVE ELECTRICAL PANELS OR ELECTRICAL GEAR. COORDINATE ROUTING WITH OTHER TRADES.

DEMOLITION GENERAL NOTES

- VISIT JOB SITE AND BECOME FULLY ACQUAINTED WITH EXISTING CONDITIONS OF PROJECT. NOTIFY ARCHITECT OF CONFLICTS OR DISCREPANCIES PRIOR TO SUBMISSION OF BID. 2. ALL CUTTING, PATCHING AND DEMOLITION WORK SHALL BE CLOSELY COORDINATED WITH EXISTING CONDITIONS AND THE REQUIRED NEW
- WORK 3. PORTIONS OF SYSTEMS ARE SHOWN FOR CLARITY, EVEN THOUGH IT MAY NOT BE NECESSARY TO MODIFY OR REVISE THEM. THESE DRAWINGS ARE ACCOMPANIED BY SPECIFICATIONS. REFER TO THE SPECIFICATIONS FOR ADDITIONAL INFORMATION.
- CONTRACTOR.

PAC	KAG	ED TEF	RMIN	IAI	_ H	EA	ΤP	JMP	SC	가	HE	ED	UL	E		
UNIT MARK	MANUF.	MODEL	CONFIG.	FAN CFM		LING SMBH		ATING HEATER MBH		ЕСТ	RICA P	MCA	O.A. CFM	WT.	ACC.	NOTES
PTAC-1	G.E.	AZ65H15DAD	HORIZ.	400	14.10	8.46	3.47	11.6	208	1	60	20	30	120		1
PTAC-2	G.E.	AZ65H15DAD	HORIZ.	400	14.10	8.46	3.47	11.6	208	1	60	20	30	120		1

NOTES: PROVIDE RAK320P LINE-CORD CONNECTION KIT, WALL SLEEVE, INTERNAL CONDENSATE REMOVAL SYSTEM, AND RAG67 EXTRUDED ALUMINUM WALL GRILLE.

SUMP PUMP SCHEDULE												
MARK	MANUF.	MODEL	TYPE	GPM	HEAD (FT)	HP	RPM	MOTOR VOLT	PH	HZ	ACC.	NOTES
SP-1	ZOELLER	M282	SUBMERSIBLE	50	20	0.5	1750	120	1	60		
SP-2	ZOELLER	M282	SUBMERSIBLE	50	20	0.5	1750	120	1	60		
NOTES	8:											

1. PROVIDE 15' CORD AND INTEGRAL FLOAT-OPERATED MECHANICAL SWITCH.

CAL DESIGN CRITERIA											
DESIGN WEATHER STATION: WICHITA EISENHOWER N	ATIONAL AIRPORT	ENERGY DATA									
COOLING WEATHER DESIGN	DATA	ASHRAE CLIMATE ZONE: COOLING DEGREE DAYS (65): HEATING DEGREE DAYS (65):	4A 1,743 4,444								
DESIGN WEATHER BASIS: DESIGN DRY BULB: MEAN COINCIDENT WET BULE	101.1 F										
DESIGN WET BULB: MEAN COINCIDENT DRY BULE	77.6 F 3: 90.7 F										
HEATING WEATHER DESIGN I	ΔΑΤΑ										
DESIGN WEATHER BASIS: HEATING DESIGN DRY BULB:											

CONCEALED EQUIPMENT, VALVES, AND DAMPERS. CEILING ACCESS DOORS FOR FIRE DAMPERS, AND FIRE SMOKE DAMPERS FURNISHED BY

NEW HVAC EQUIPMENT SHALL NOT BE USED DURING CONSTRUCTION. CONTRACTOR SHALL FURNISH ALL NECESSARY TEMPORARY HEATING

COORDINATE ROUTING OF PLUMBING AND FIRE PROTECTION PIPING WITH DUCTWORK, LIGHTS, ARCHITECTURAL CEILING AND STRUCTURAL OVER ALL PIPING, INCLUDING FIRE SPRINKLER PIPING EXCEPT WHERE GRADE MUST BE MAINTAINED FOR DRAINAGE. PROVIDE ADDITIONAL MANUAL AIR VENTS FOR PIPING WHERE REQUIRED FOR PIPING TO OFFSET. FIRE PROTECTION CONTRACTOR SHALL PROVIDE ADDITIONAL

1. PLANS ARE SCHEMATIC IN NATURE. LAYOUT IS BASED ON BEST AVAILABLE INFORMATION. PRIOR TO SUBMITTING BID CONTRACTOR SHALL

5. THE OWNER SHALL HAVE THE OPTION TO KEEP ANY EQUIPMENT THAT IS TO BE REMOVED. OTHERWISE, IT IS TO BE DISPOSED OF BY THIS



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PTION DATE
00939R25001
CERTIFIED FINAL
6/12/25

MECHANICAL PLANS



SYMBOL LIST

SYMBOL	DESCRIPTION	MOUNTING
A	LED FIXTURE & FIXTURE LETTER	CEILING
$\vdash \widehat{A} \dashv$	LED FIXTURE & FIXTURE LETTER	CEILING
\ominus	GFCI DUPLEX GROUNDED RECEPTACLE	1'-6" AFF
	EXTERIOR GFCI RECEPT. WEATHERPROOF	1'-6" AFF
\checkmark	PHONE/DATA OUTLET	1'-6" AFF
\supset	DATA OUTLET	1'-6" AFF
\$\$ ₃ \$ ₄ \$ _D \$ _K \$ _P	SWITCHES (1-POLE,3-WAY,DIMMER,KEY,PILOT)	4'-0" TO TOP
J	JUNCTION BOX	
A	BRANCH CIRCUIT PANEL & PANEL DESIG.	6'-6"TO TOP
⊠ 30/3/240	H.D. SAFETY SWITCH (AMPS,POLE,VOLTAGE)	6'-6"TO TOP
⊠ 0/3/240	STARTER (SIZE, POLE, VOLTAGE)	6'-6"TO TOP
X	PLAN NOTE	
•	MOTOR	
	CONDUIT RUN W/ CONDUCTORS SEE NOTE #7	CEIL./WALL
	CONDUIT RUN 2 CIRCUIT, SEE NOTE #7	EARTH/FLOOR
\checkmark	PARTIAL HOMERUN (MULTIPLE LOAD LOCATIONS)	
30.3 30/3	FEEDER 30.3 30A CIRCUIT SEE NOTE #7	
XXX.X	FEEDER IDENTIFICATION, SEE SCHEDULE	
EX	EXISTING	
СМ	CEILING MOUNT	
WP	WEATHERPROOF	
a,b,c	INDICATES SWITCHING SCHEME	
$\langle \bullet \rangle$	AREA SMOKE DETECTOR	CEIL./WALL
$\langle H \rangle$	AREA HEAT DETECTOR	CEILING

GENERAL NOTES

- VERIFY ALL OUTLET LOCATIONS ON THE JOB PRIOR TO ROUGH-IN.
- REFER TO RELATED ARCHITECTURAL, MECHANICAL, AND STRUCTURAL DRAWINGS FOR RELATED INFORMATION.

ICE

- REFER TO THE SPECIFICATIONS FOR DATA NOT ON THE DRAWINGS.
- COORDINATE OUTLET BOX LOCATIONS WITH MASONRY TO MINIMIZE CUTTING OF BRICK OR BLOCK.
- WALL MOUNTING HEIGHTS TO CENTERLINE OF DEVICE UNLESS OTHERWISE NOTED.
- E.C. SHALL REFER TO MECHANICAL DRAWINGS AND SPECIFICATIONS FOR THE REQUIREMENTS ASSOCIATED WITH WIRING AND CONNECTION OF INTERLOCKING AND CONTROLS OF MECHANICAL UNITS AND THERMOSTAT LOCATIONS.
- CONDUIT RUN W/CONDUCTORS AS INDICATED, CONDUIT SIZE AS REQUIRED. CONDUIT RUN TO PANEL DEVICE SIZE AS INDICATED (AMP/ POLE). CIRCUIT WITHOUT INDICATION IS ROUTED TO 20A., 1P. BREAKER. CONDUCTOR COUNT IS NOT SHOWN ON THE DRAWINGS FOR #12 SIZE CONDUCTORS. ELECTRICAL CONTRACTOR SHALL PROVIDE NUMBER OF CONDUCTORS AS REQUIRED FOR CIRCUITING, SWITCHING AND/OR CONTROL AS REQUIRED. ALL REQUIREMENTS OF THE CURRENT NATIONAL ELECTRICAL CODE SHALL BE FOLLOWED FOR CONDUIT FILL AND CONDUCTOR DE-RATING IF APPLICABLE.
- A GROUND CONDUCTOR SIZED PER N. E. C. ARTICLE 250 IS REQUIRED IN ALL POWER, RECEPTACLE, AND LIGHTING CIRCUITS. GROUND CONDUCTORS ARE NOT SHOWN ON DRAWINGS.

PLAN NOTES ICE - SC PUBLIC PARKING GARAGE		
SYMBOL	DESCRIPTION	
1	REMOVE AND REPLACE EXISTING FIXTURE WITH WILLIAMS # 76R-4-L52/840-EM/10W-DIM-UNV. PROVIDE HOT CONNECTION FOR BATTERY.	
2	ELEVATOR DISC. SWITCH, 60A. 3P. 600V FUSED AT 60A. PROVIDE WITH CONTACTS TO TIE TO ELEVATOR CONTROLS.	
3	TO 20A 120V CIRCUIT BACK TO EXISTING PANEL "P" (LOCKABLE COVER ON FUSTAT).	
4	CAT 6E DATA CABLE IN RGS CONDUIT BACK TO TELEPHONE TERMINAL BOARD IN WEST ELECTRICAL CLOSET FOR COMMUNICATIONS AND VIDEO.	
5	TO 20A 1P. BREAKER IN EXISTING PANEL "P"	
6	REMOVE AND REPLACE PTAC UNIT. INSTALL NEW 20A 2P. BREAKERS IN EXISTING PANEL "P" 2 #12 & 1 #12 GRD-1/2"C TO 20A 208V RECEPTACLE TO MATCH CORD PROVIDED WITH PTAC UNIT.	
7	CONTRACTOR SHALL REMOVE - EXISTING ELEVATOR CONNECTIONS, HVAC FEEDER, FEEDERS, COMMUNICATIONS CABLE AND INSTALL NEW AS INDICATED. PROJECT TO BE DONE IN PHASES. EAST ELEVATOR PHASE 1.	
8	REMOVE AND INSTALL NEW SMOKE OR HEAT DETECTOR, SIMILAR TO EXISTING, RECONNECT TO CIRCUIT AND CONTROLS.	

